

DESIGN AND CONSTRUCTION OF CIVIL, STRUCTURES AND TRACK WORKS FOR DOUBLE LINE RAILWAY INVOLVING FORMATION IN EMBANKMENTS/CUTTINGS, BALLAST ON FORMATION, TRACK WORKS, BRIDGES, STRUCTURES, BUILDINGS, YARDS, INTEGRATION WITH IR EXISTING RAILWAY SYSTEM AND TESTING & COMMISSIONING ON DESIGN-BUILD LUMP SUM BASIS FOR DADRI - KHURJA SECTION OF EASTERN DEDICATED FREIGHT CORRIDOR

> Contract Package: 302 ICB No. HQ/EN/EC/D-B/DADRI - KHURJA **PART - 4 - REFERENCE DOCUMENT DRAWINGS - VOLUME - 5.4**

> > DADRI - KHURJA From Km. 1413.856 to Km. 1367.000

OTHER DRAWINGS

EMPLOYER DEDICATED FREIGHT CORRIDOR CORPORATION OF INDIA LIMITED (A GOVERNMENT OF INDIA ENTERPRISES) MINISTRY OF RAILWAYS **COUNTRY : INDIA**

CONTENTS OTHER DRAWINGS (CONTRACT PACKAGE 302)

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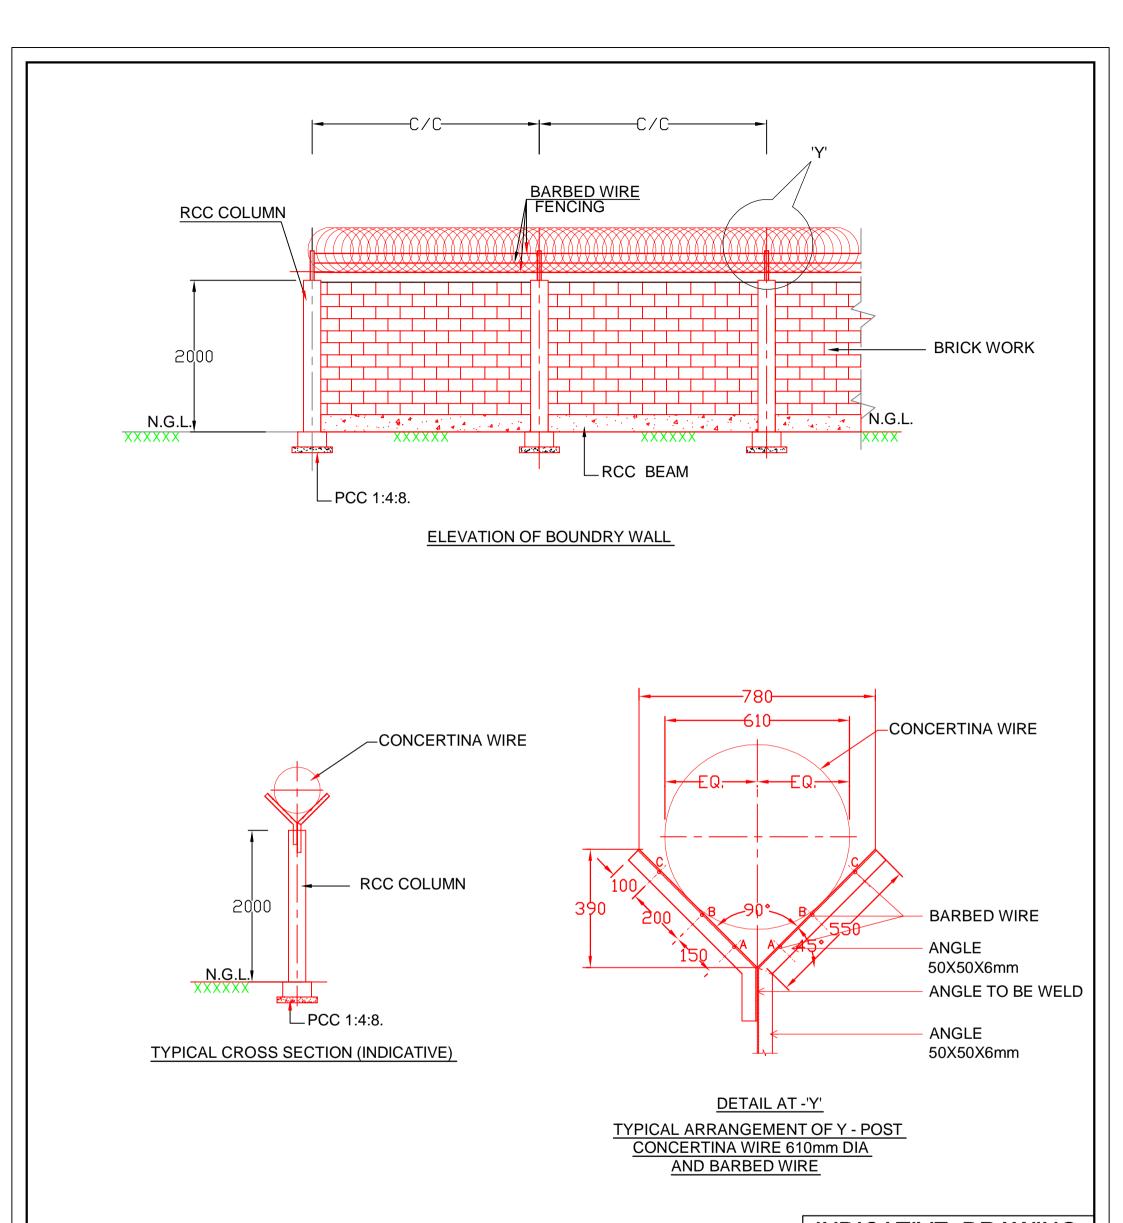
	CONTENTS OTHER DRAWINGS (CONTRACT PACKAGE 302)								
SL. NO.	DESCRIPTION	DRAWING NO.	REVISION NO.	REMARKS	SL. NO.	DESCRIPTION	DRAWING NO.	REVISION NO.	REMARKS
1	TYPICAL GAD FOR BOUNDARY WALL	DFCC/BOUNDARY WALL/TYP-001	R0		31			$-\uparrow$	
2	TYPICAL GAD FOR STATION BUILDING FOR JUNCTION STATION (GF & FF)	GC/DFCC/JS/101	R0		32				
3	TYPICAL GAD FOR STATION BUILDING FOR JUNCTION STATION (ELEVATION)	GC/DFCC/JS/102	R0		33				
4	TYPICAL GAD FOR INTEGRATED MAINTENANCE SUB DEPOT (IMSD)	GC/DFCC/IMSD/401	R0		34				
5	TYPICAL DRAWING FOR SEE THROUGH FENCING	DFC/2015/FEN/TYP	R0		35				
6	TYPICAL GAD FOR TYPE 'A' QUARTER	GC/DFCC/QRTS/701	R0		36				
7	TYPICAL GAD FOR TYPE 'B' QUARTER	GC/DFCC/QRTS/702	R0		37				
8	TYPICAL GAD FOR EARTHING ARRANGEMENT ON BRIDGES	HQ/EL/OHE/Pt.1/Earthing	R0		38				
9	TYPICAL DRAWING FOR FIXING OF OHE MAST ON BRIDGE PIER	HQ/EL/OHE/Pt.1/Mast	R0		39				
10	TYPICAL DRAWING MINIMUM BALLAST PROFILE B.G. FOR LOOPS FOR STRAIGHTS, CURVES	DFC/2015/BF/01	R0		40				
11	TYPICAL DRAWING MINIMUM BALLAST PROFILE DOUBLE LINE B.G. FOR STRAIGHTS & CURVES	DFC/2015/BF/03	R0		41				
12	TYPICAL DRAWING FOR TYPE II IR QUARTERS	NCR HQE (P) PLAN NO. P-49-2004	R0		42				
13	TYPICAL DRAWING FOR TYPE III IR QUARTERS	NCR HQE (P) PLAN NO. P-50-2004	R0		43				
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30									

GENERAL CO	NSULTANT	TITLE	Æ	DE
AECOM	AECOM Asia Co. Ltd. 9TH FLOOR, INFINITY TOWER C DLF CYBER CITY DLF PHASE II GURGAON 122002, INDIA	CONTENTS OTHER DRAWINGS	. डेडीकेटेड फ्रेंट कोरीडोर	
		(302)	PROJECT	

DEDICATED FREIGHT CORRIDOR CORPORATION OF INDIA LTE (A GOVERNMENT OF INDIA ENTERPRISE)

EASTERN CORRIDOR

DADRI TO KHURJA




NOTES:-

1. ALL DIMENSIONS ARE IN MILLIMETERS UNLESS NOTED OTHERWISE.


2. WRITTEN DIMENSIONS ARE TO BE FOLLOWED. DRAWINGS ARE NOT TO BE SCALED.

3. DEPTH OF FOUNDATION AND C/C OF RCC COLUMN WILL BE DEPEND UPON SITE CONDITION.


		DRA	WING			
DEDICATED FREIGHT CORRIDOR CORPORATION OF INDIA LTD.						
detail TYPI	DETAIL TYPICAL GENERAL ARRANGEMENT DRAWING FOR BOUNDARY WALL					
SCALE	N.T.S.					
DRG.NO.	DFCC/BOUNDARY WALL/TYP-00	1				
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STATION BUILDING (For Junctions Stations)

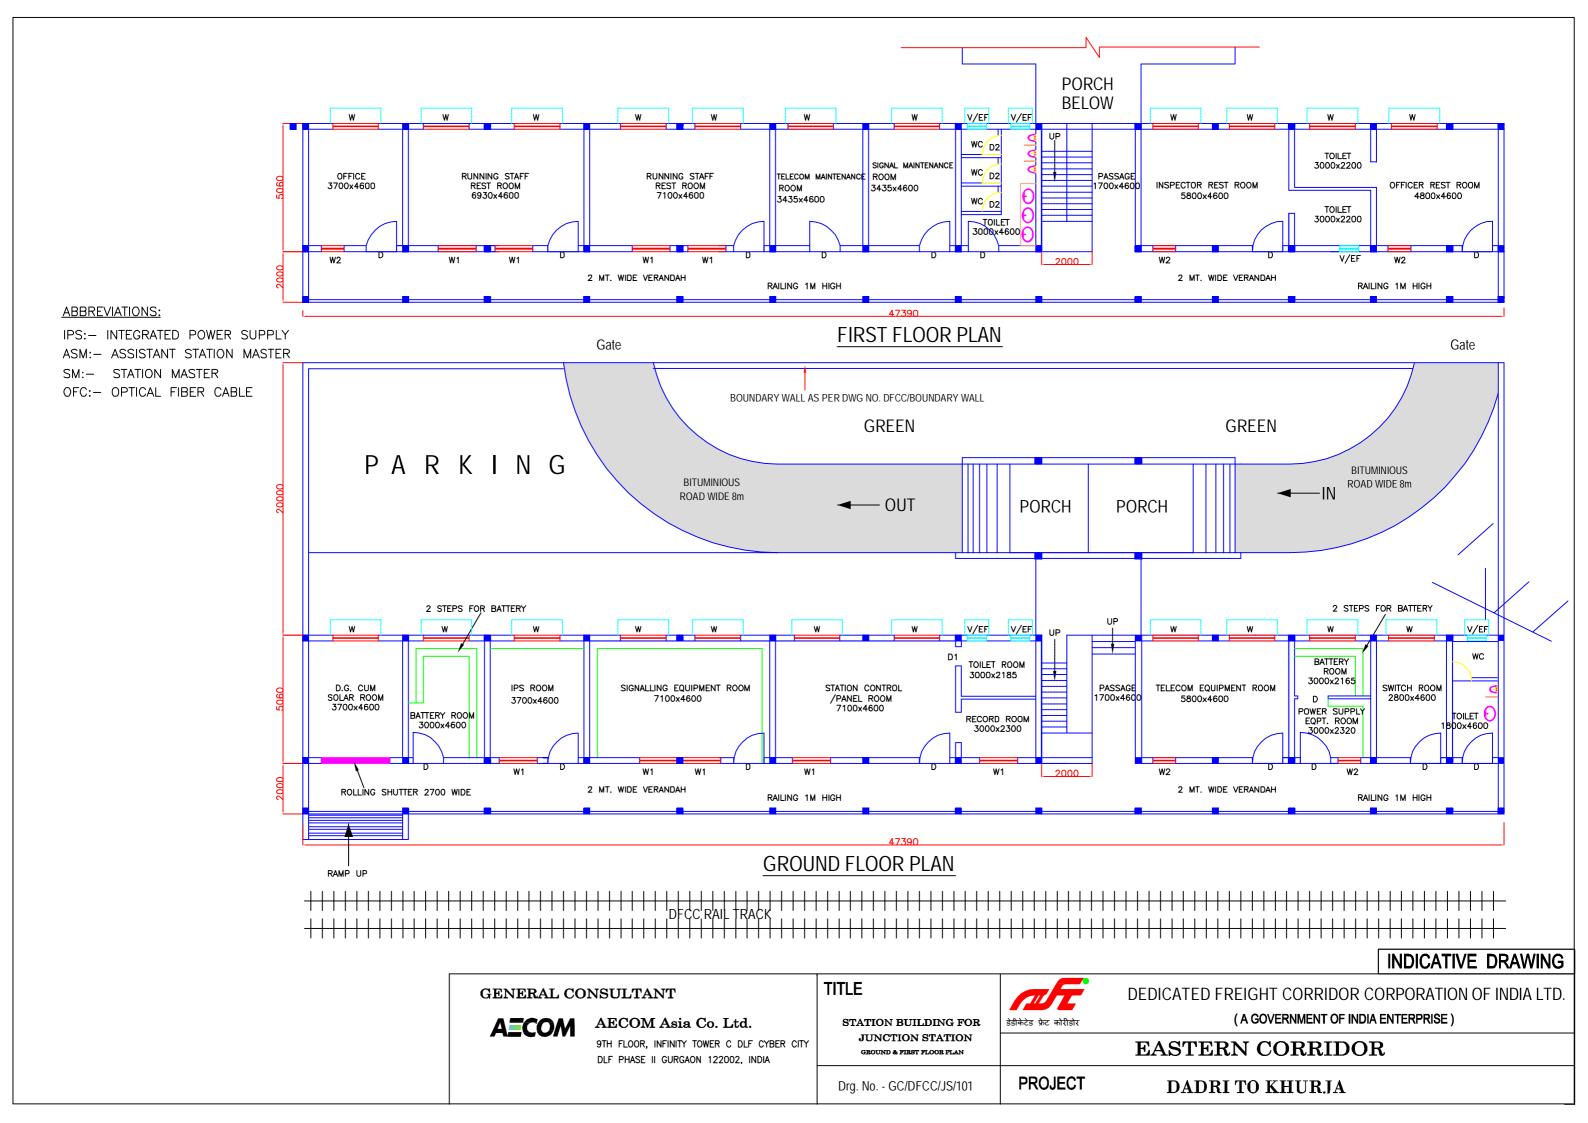


REAR ELEVATION

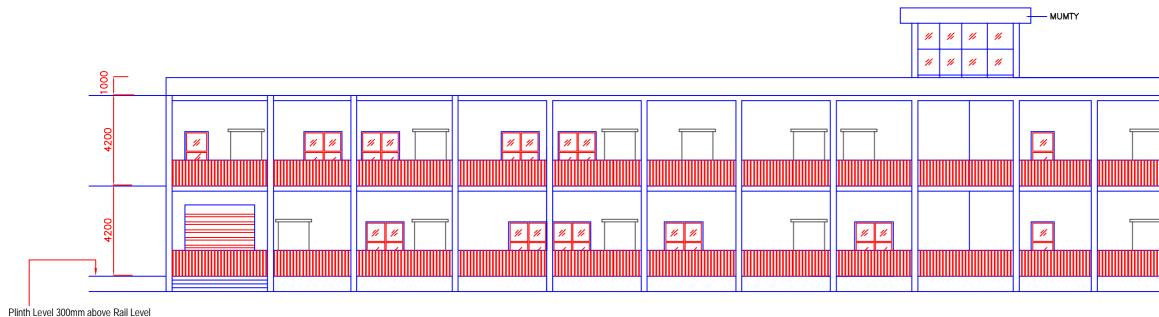


Plinth Level 300mm above Rail Level

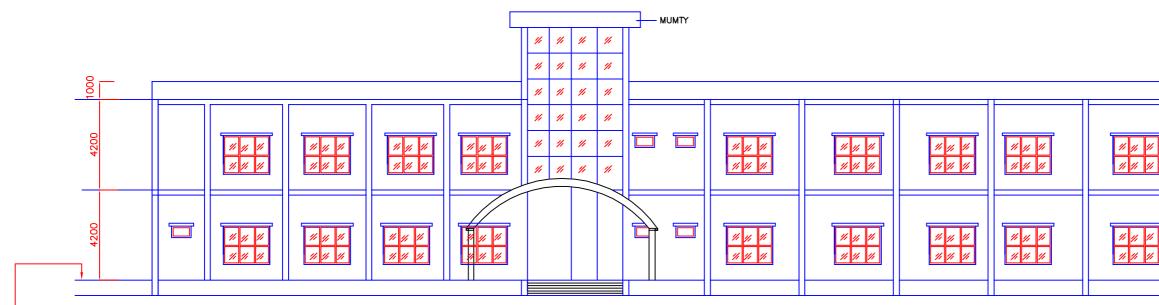FRONT ELEVATION

GENERAL CO	NSULTANT	TITLE	Æ	DEDICATED
AECOM	AECOM Asia Co. Ltd.	STATION BUILDING FOR JUNCTION STATION	डेडीकेटेड फ्रेट कोरीडोर	
	9TH FLOOR, INFINITY TOWER C DLF CYBER CITY DLF PHASE II GURGAON 122002, INDIA	FRONT & REAR BLEVATION		EASTI
		Drg. No GC/DFCC/JS/102	PROJECT	DAD

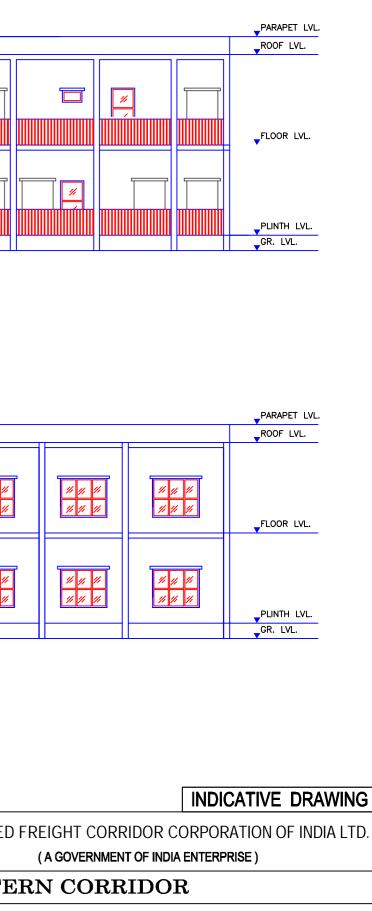

ORI - KHUR.JA

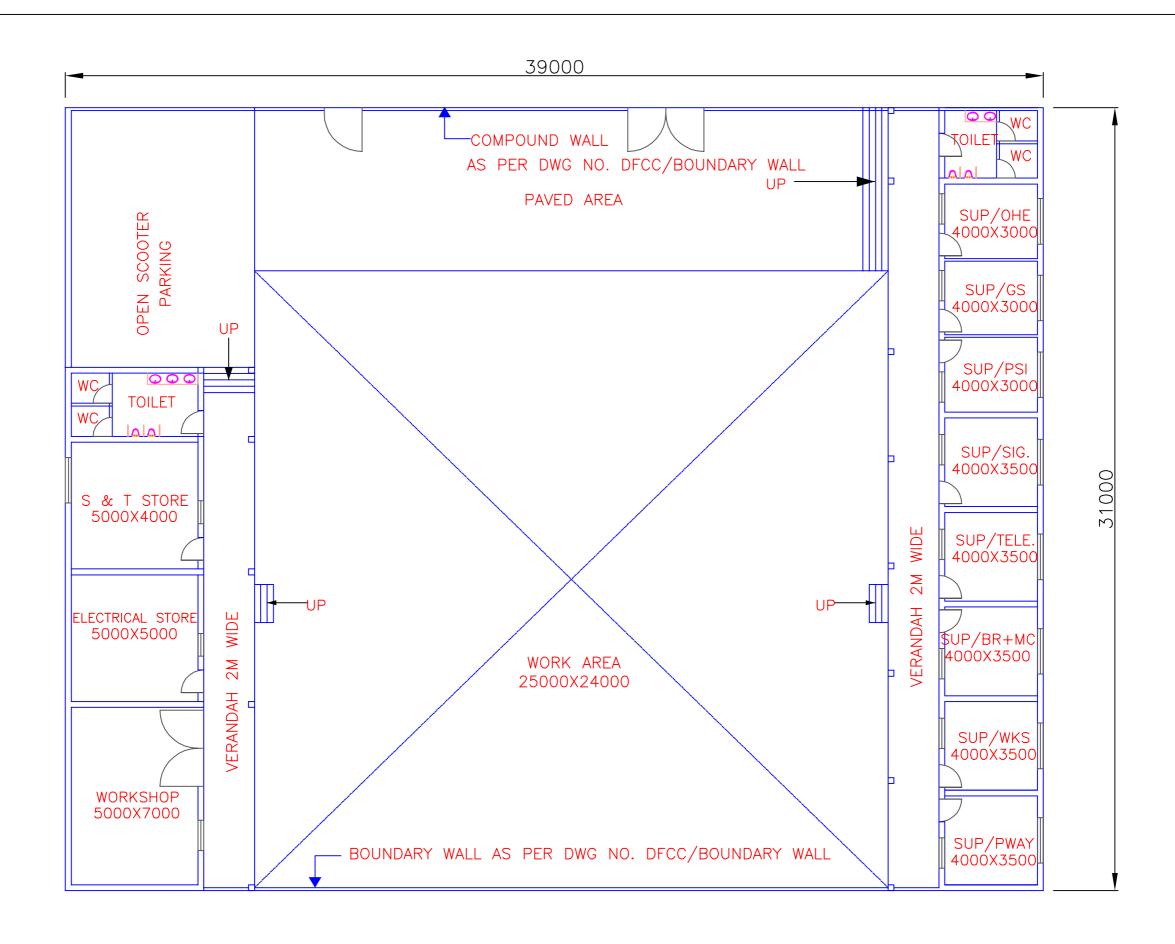


GENERAL CO	NSULTANT	TITLE	Æ	DEDICATE
AECOM	AECOM Asia Co. Ltd.	INTEGRATED MAINTENANCE	डेडीकेटेड फ्रेट कोरीडोर	
	9TH FLOOR, INFINITY TOWER C DLF CYBER CITY DLF PHASE II GURGAON 122002, INDIA	SUB DEPOT (IMSD) ground floor plan		EASTI
		Drg. No GC/DFCC/IMSD/401	PROJECT	D

INDICATIVE DRAWING

D FREIGHT CORRIDOR CORPORATION OF INDIA LTD. (A GOVERNMENT OF INDIA ENTERPRISE)

ERN CORRIDOR

ADRI - KHURJA

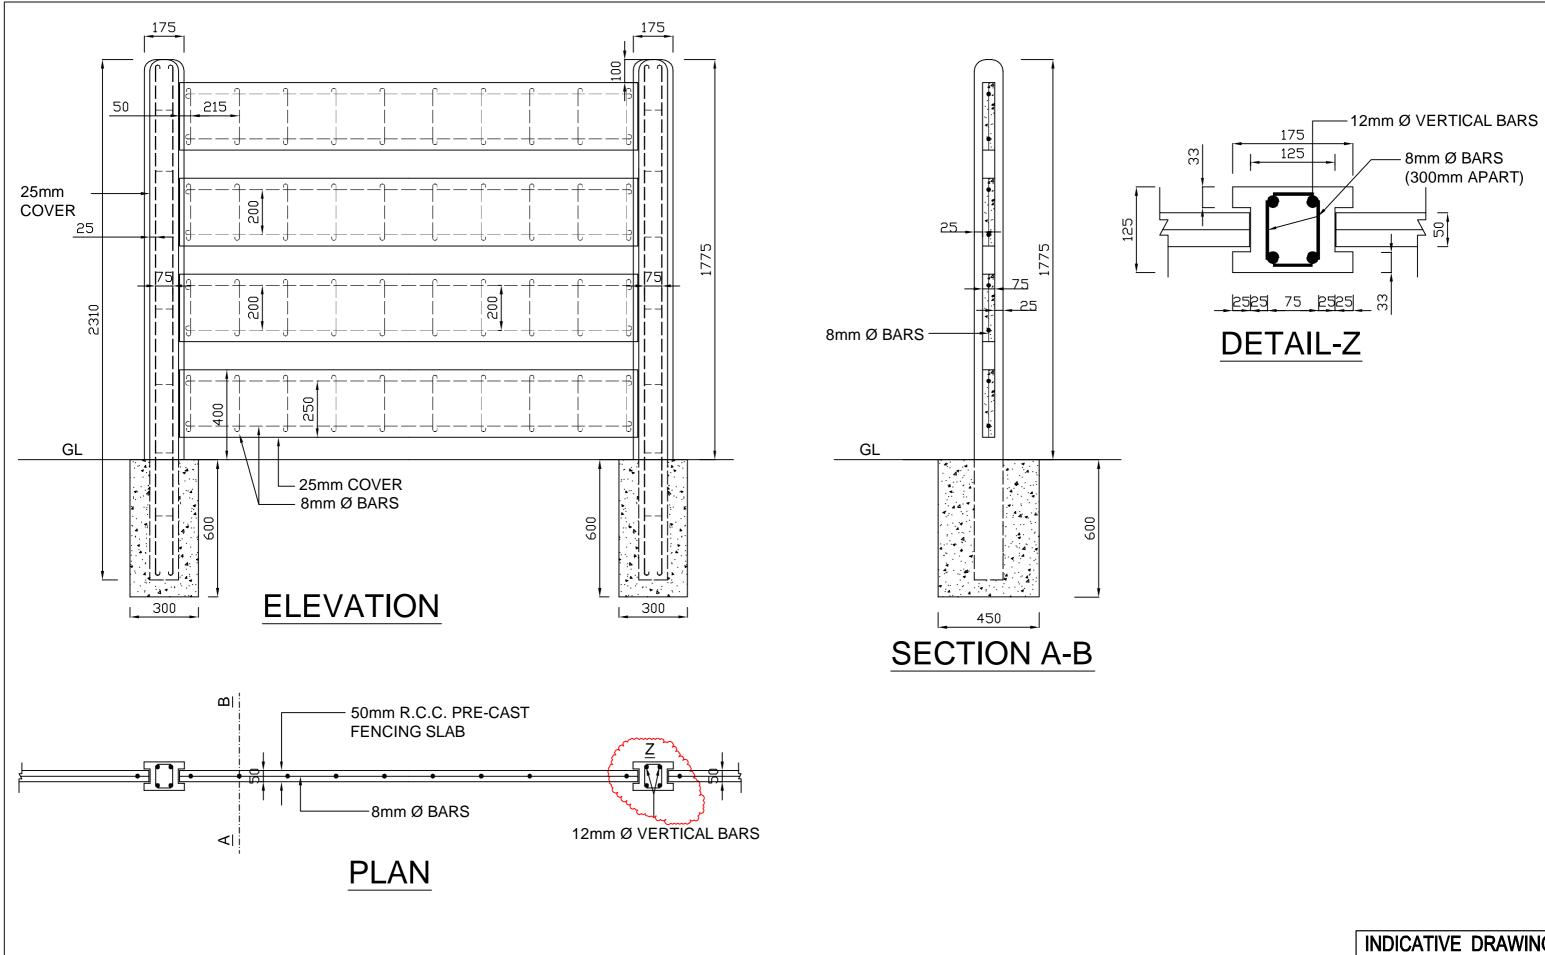

GENERAL CO	NSULTANT	TITLE		"af
AECOM	AECOM Asia Co. Ltd. 9TH FLOOR, INFINITY TOWER C DLF CYBER CITY DLF PHASE II GURGAON 122002, INDIA		TYPICAL DRAWING THROUGH FENCING	डेडीकेटेड फ्रेंट कोरी
		Drg No.	DFC/2015/FEN/TYP	PROJECT


INDICATIVE DRAWING




DEDICATED FREIGHT CORRIDOR CORPORATION OF INDIA LTD. (A GOVERNMENT OF INDIA ENTERPRISE)

EASTERN CORRIDOR

DADRI - KHURJA

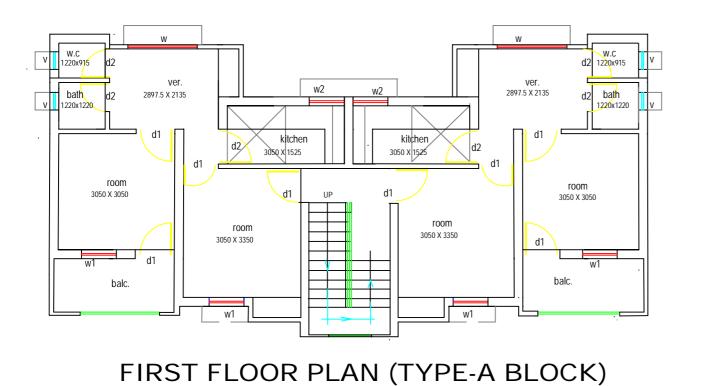


NOTES:-Number of Quarter and their location shall be decided by employer at each station.

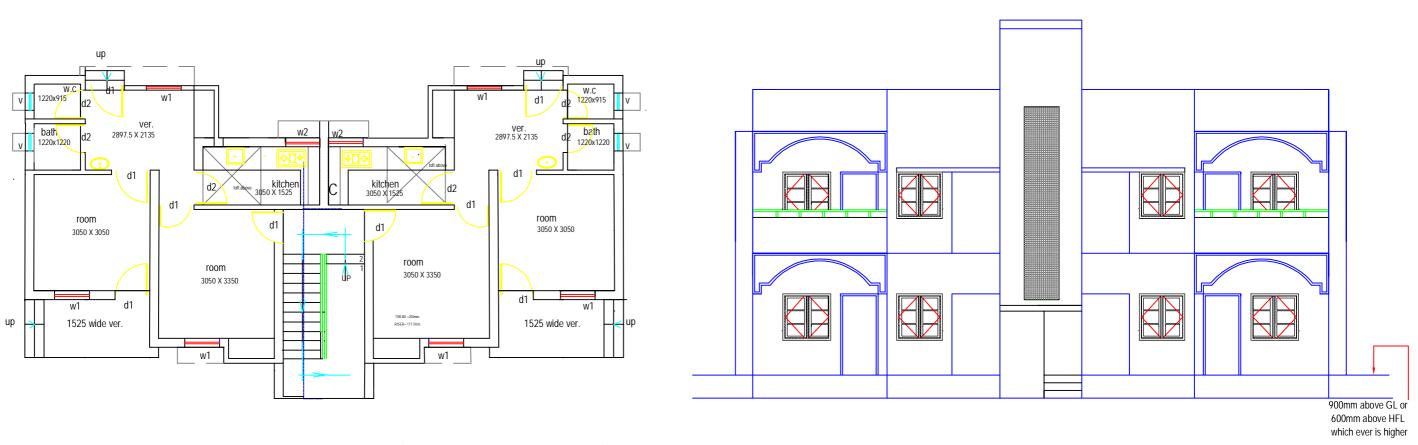

GROUND FLOOR PLAN (TYPE-A BLOCK)

GENERAL CO	NSULTANT	TITLE	Æ	DEDICATED F
AECOM	AECOM Asia Co. Ltd.	TYPE - A QUARTER	डेडीकेटेड फ्रेट कोरीडोर	
	9TH FLOOR, INFINITY TOWER C DLF CYBER CITY DLF PHASE II GURGAON 122002, INDIA	GROUND, FIRST FLOOR PLAN AND ELEVATION		EASTER
		Drg. No GC/DFCC/QRTS/701	PROJECT	DADR

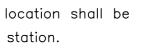


FRONT ELEVATION (TYPE-A BLOCK)

INDICATIVE DRAWING FREIGHT CORRIDOR CORPORATION OF INDIA LTD. (A GOVERNMENT OF INDIA ENTERPRISE)


RN CORRIDOR

RI - KHURJA

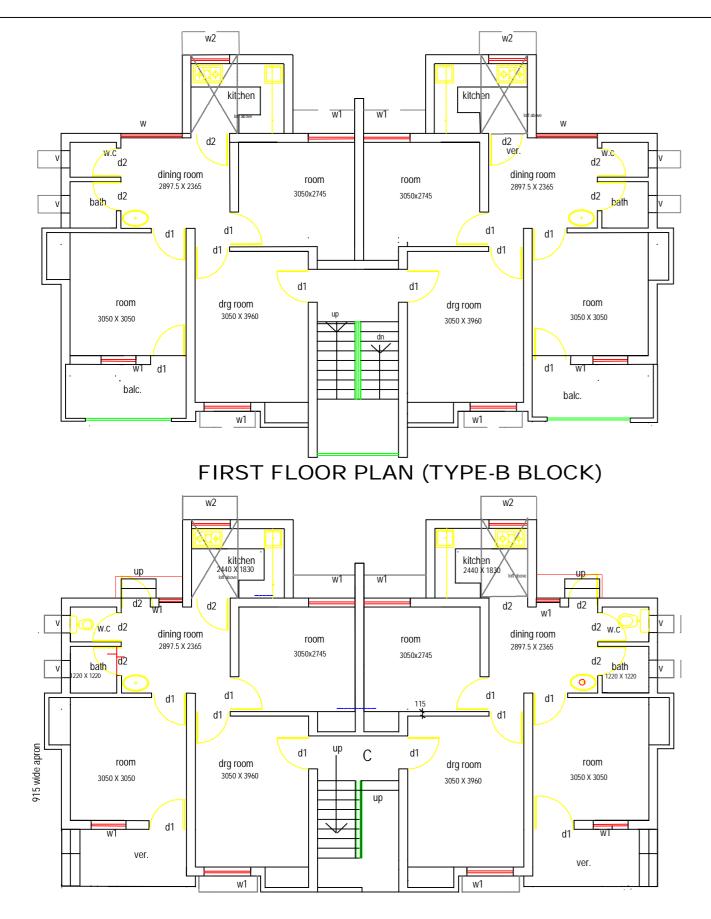

NOTES:-


Number of Quarter and their location shall be decided by employer at each station.

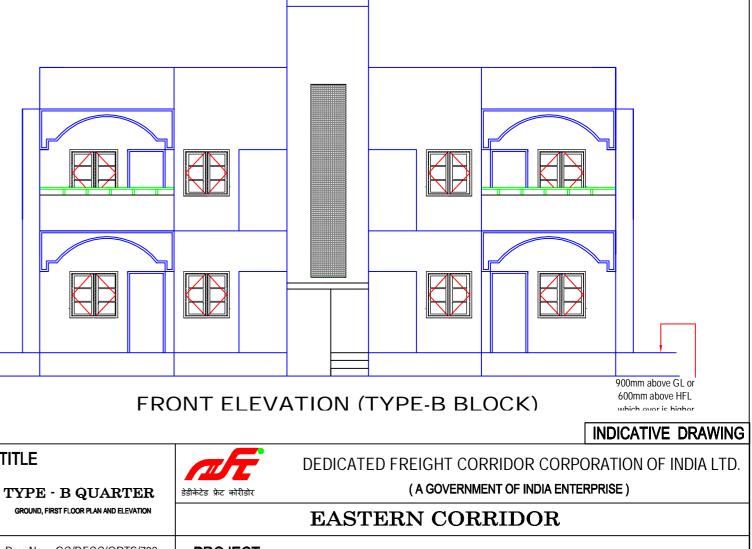


GROUND FLOOR PLAN (TYPE-B BLOCK)

GENERAL CO	NSULTANT	TITLE	Æ	DEDICATED F
AECOM	AECOM Asia Co. Ltd.	TYPE - B QUARTER	डेडीकेटेड फ्रेट कोरीडोर	
	9TH FLOOR, INFINITY TOWER C DLF CYBER CITY DLF PHASE II GURGAON 122002, INDIA	GROUND, FIRST FLOOR PLAN AND ELEVATION		EASTER
		Drg. No GC/DFCC/QRTS/702	PROJECT	DADR

RI - KHURJA

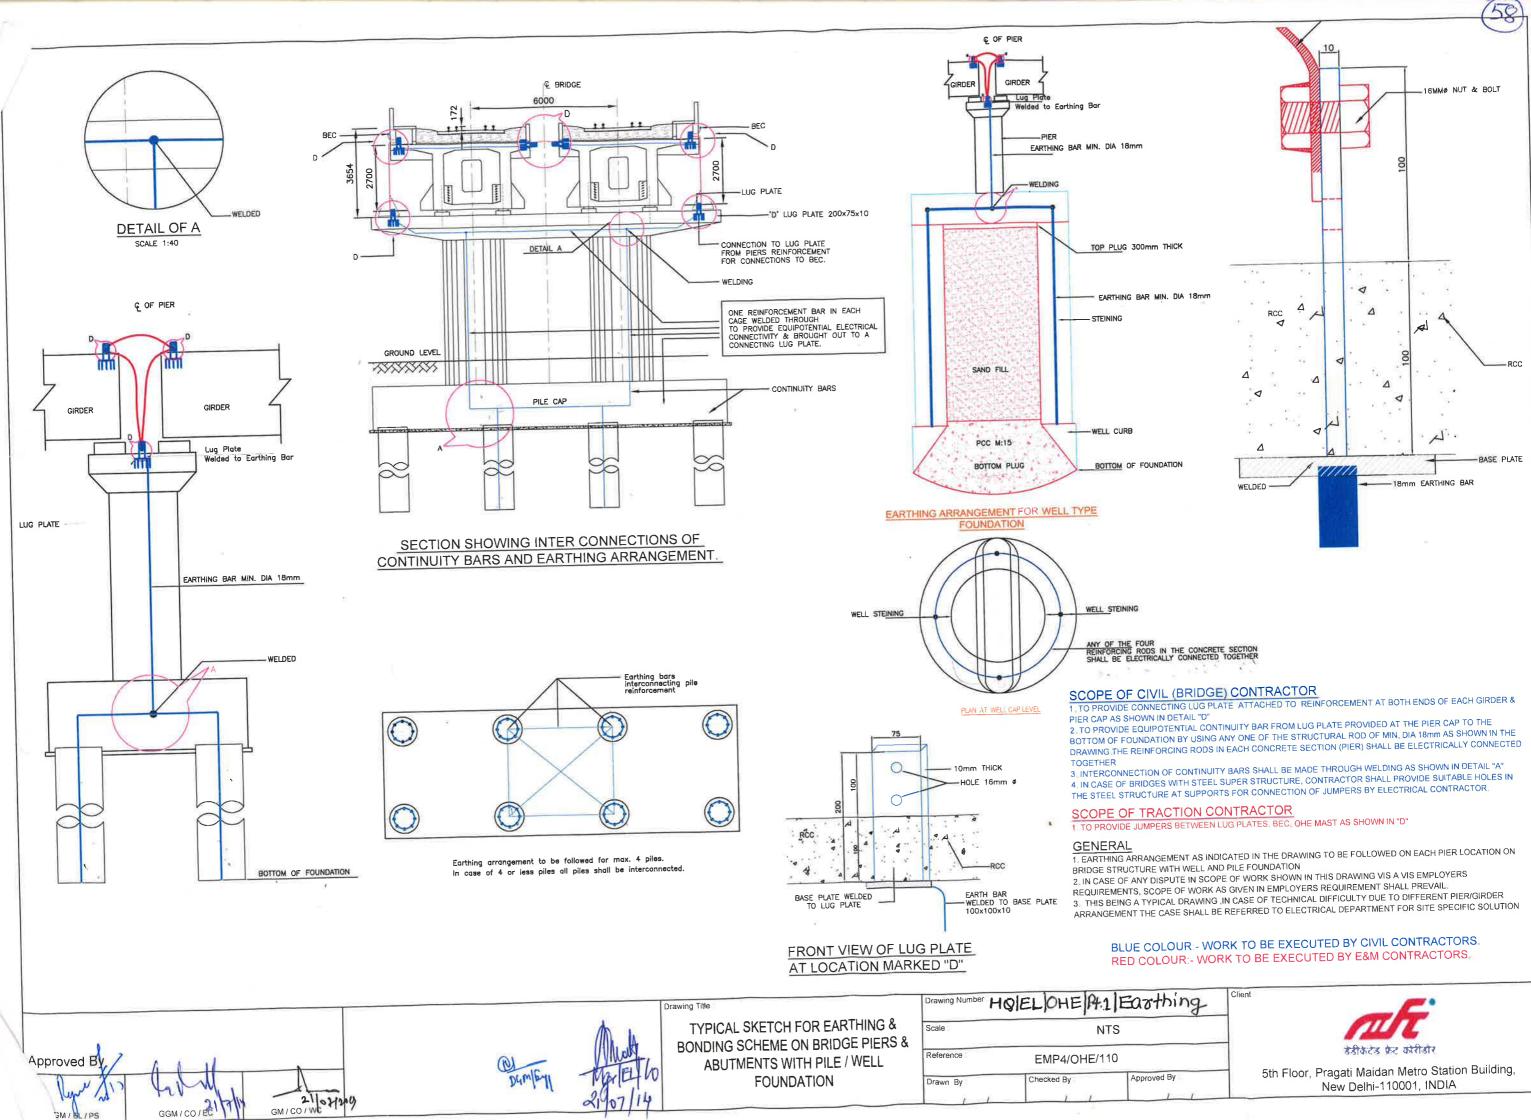

thing	Client
	इंडीकटंड क्रेट कोरीडोर
ved By	5th Floor, Pragati Maidan Metro Station Building, New Delhi-110001, INDIA
1_1	

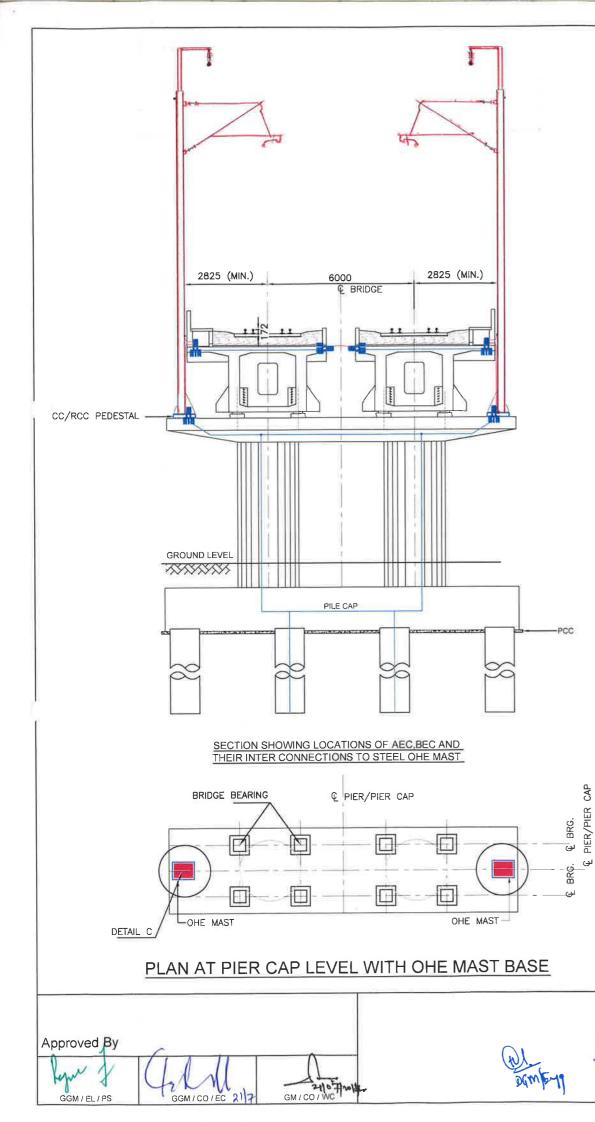

HOLES FOR HD BOLTS


GENERAL

REQUIREMENTS. SOLUTION


Drawing Number HQIEL OHE PH1 Mast TYPICAL SKETCH FOR FIXING OF OHE Scale NTS Reference EMP4/OHE/110 Checked By Approved By Drawn By

Drawing Title

MAST ON BRIDGE PIER

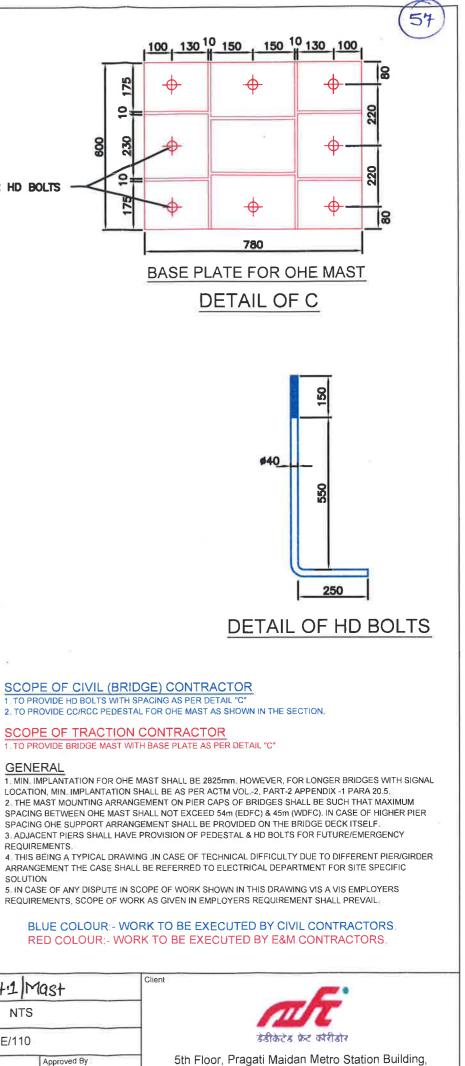

New Delhi-110001, INDIA

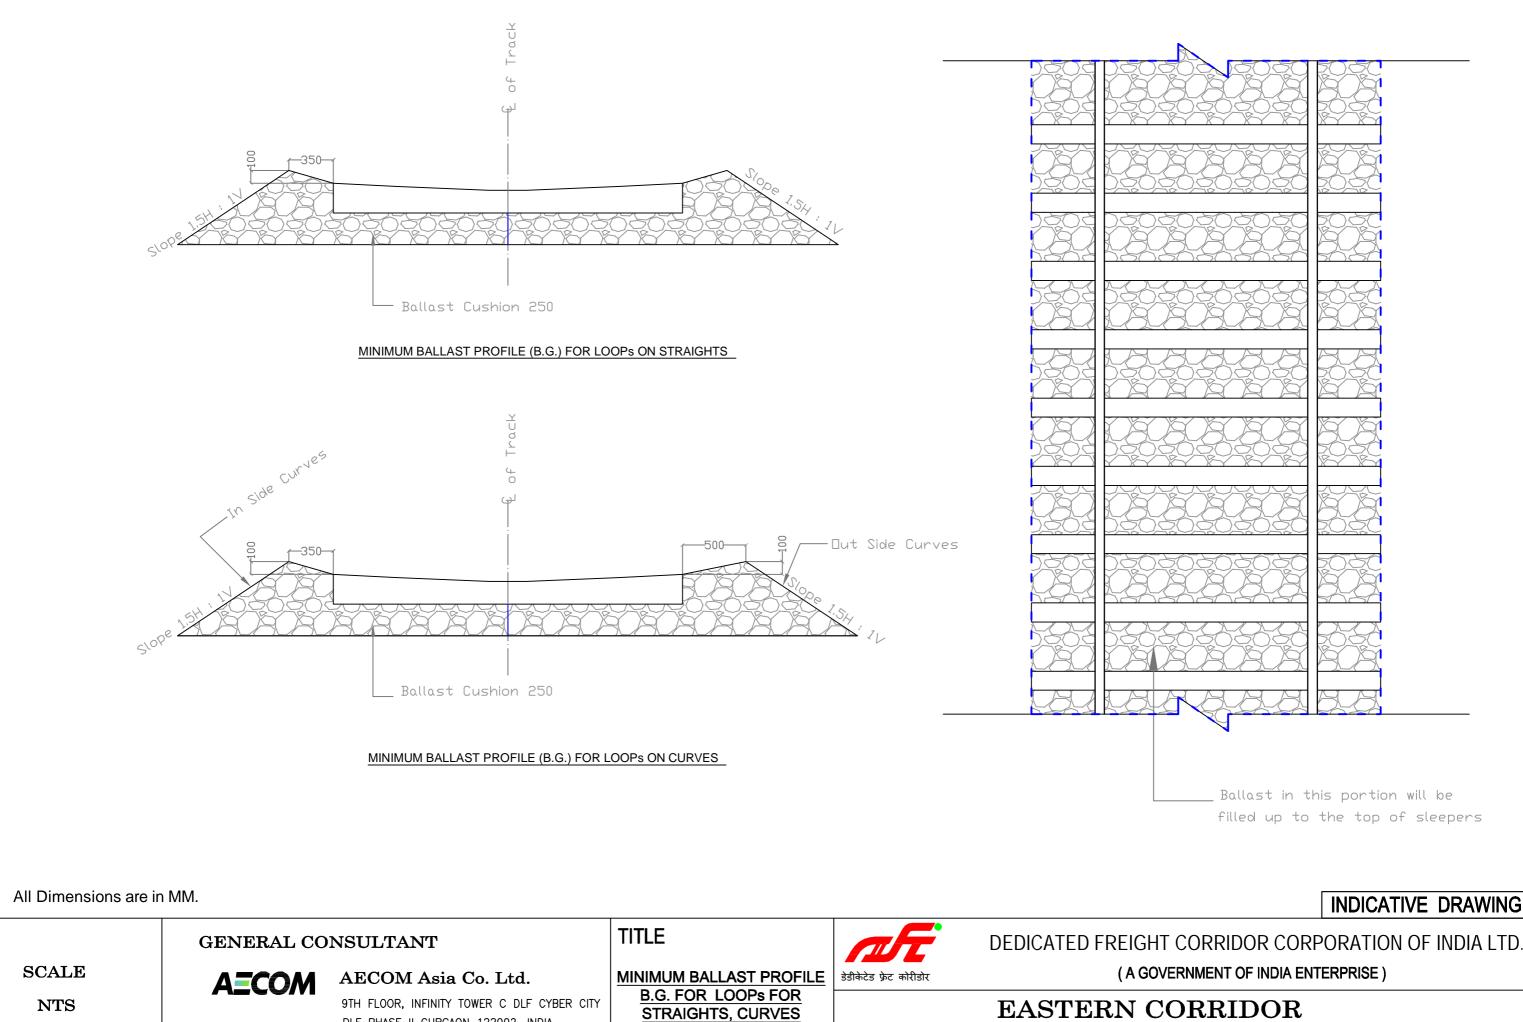



Drg No. DFC/2015/BF/01 PROJECT

DLF PHASE II GURGAON 122002, INDIA

PILKHANI TO SAHNEWAL

INDICATIVE DRAWING

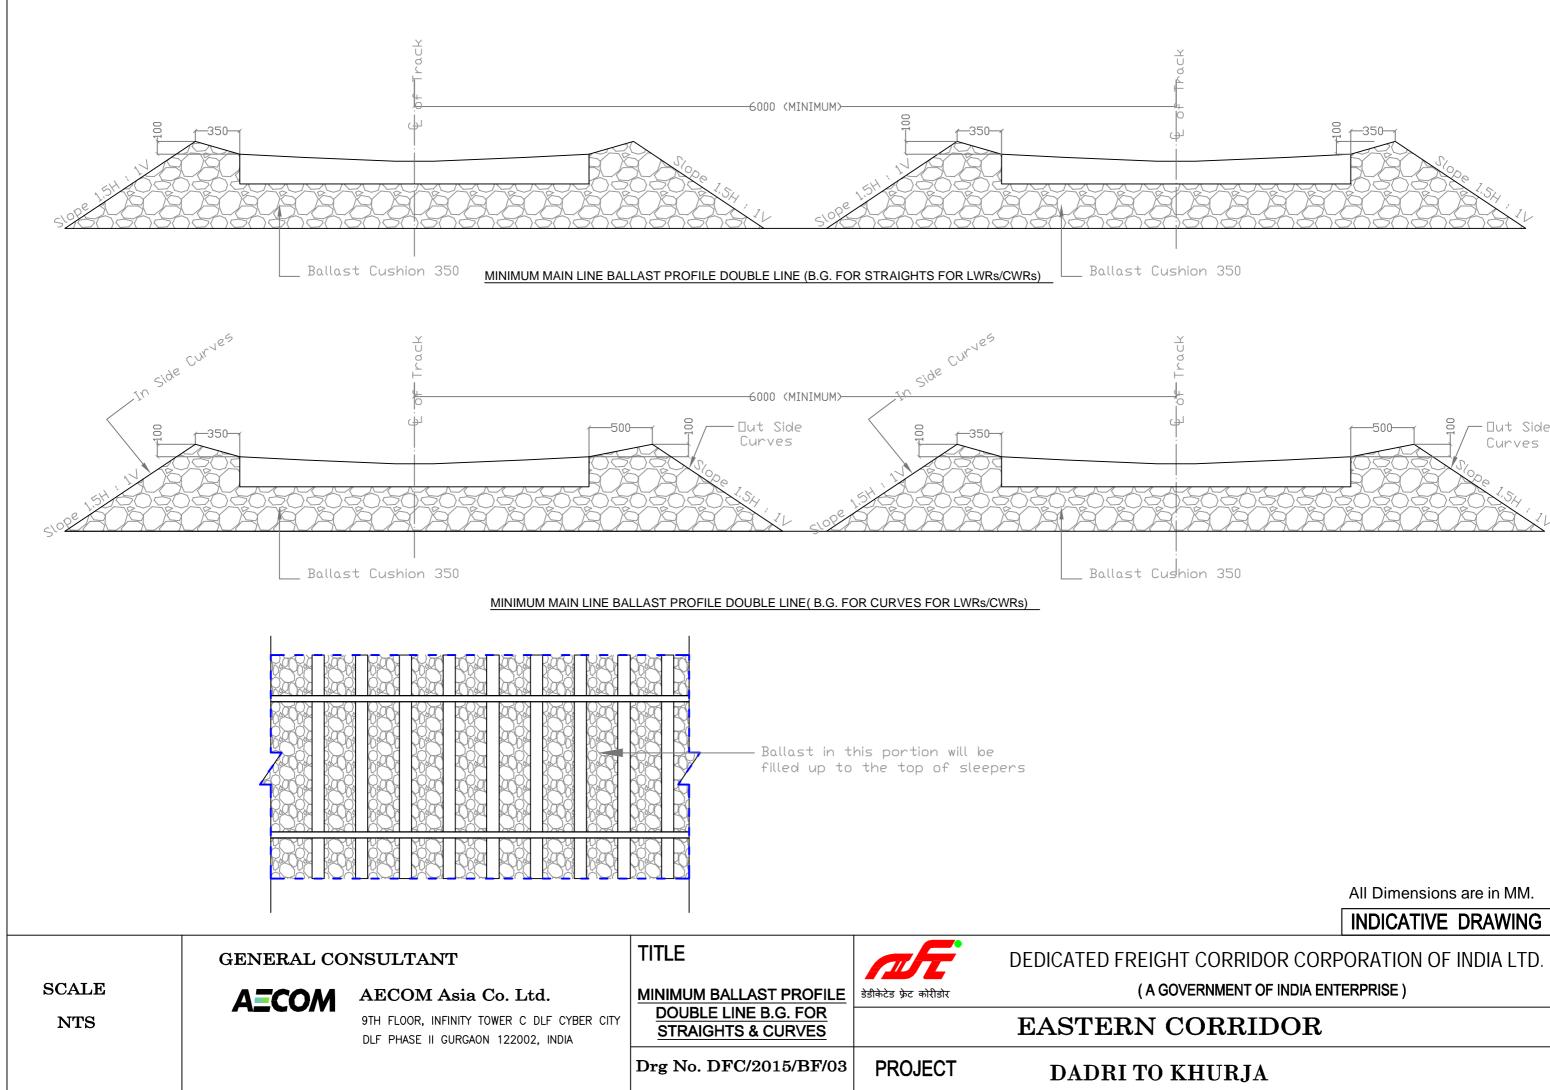

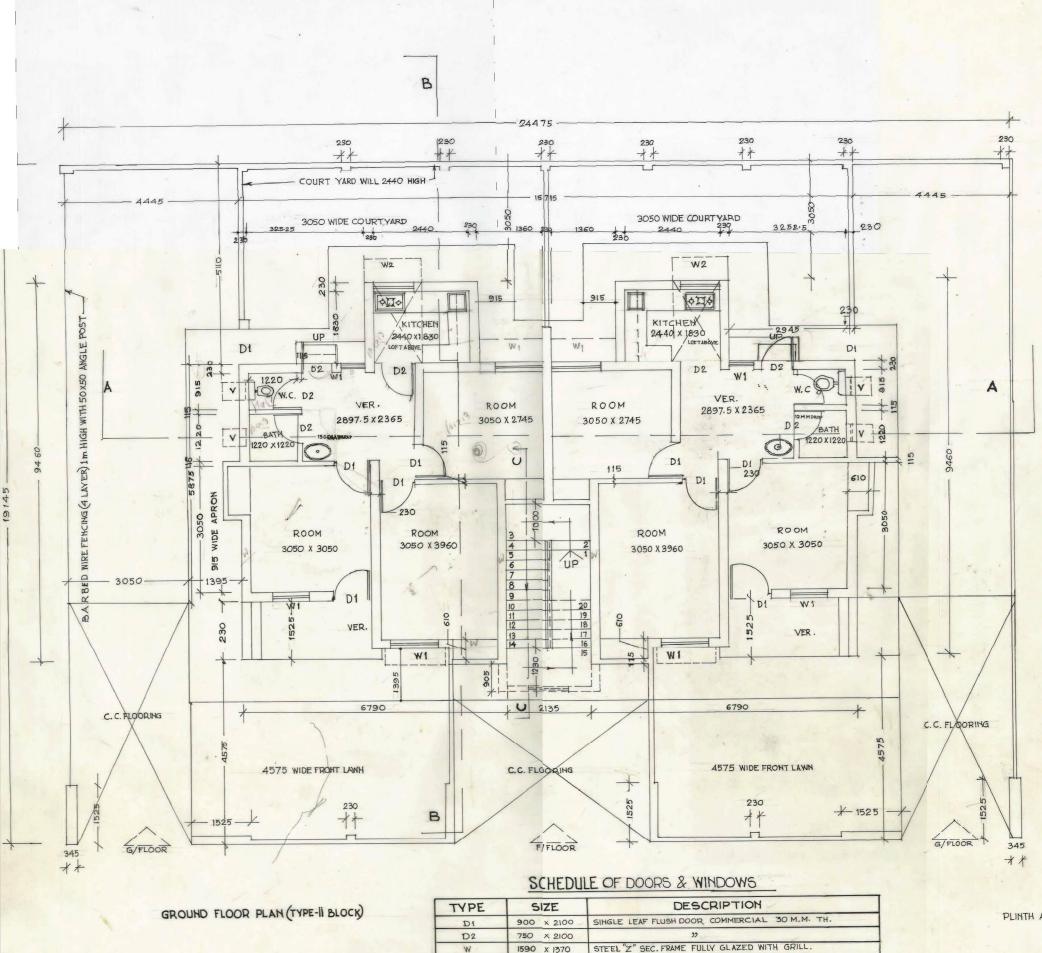

900 X 1370

900 X 1140

600 X 450

WI

W2

V


J.C. CHAKRAN

STEEL "Z" SEC. FRAME FULLY GLAZED WITH TOP HINGES.


PLINTH AREA = 55.47 m^2

sd-11/3/04 R.K. SHRIHAR sdsd-N.P. SINGH. B.K. GUPTA AXEN/C-II/ALD DY. CE/C/ALD DY.CE/C/DESGNING CE/C/HQ.

NCR HQE (P) PLAN NO. P-49-2004

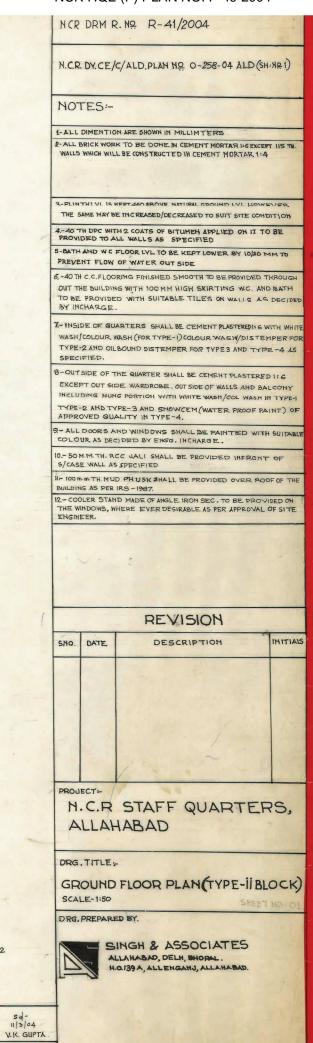

50-

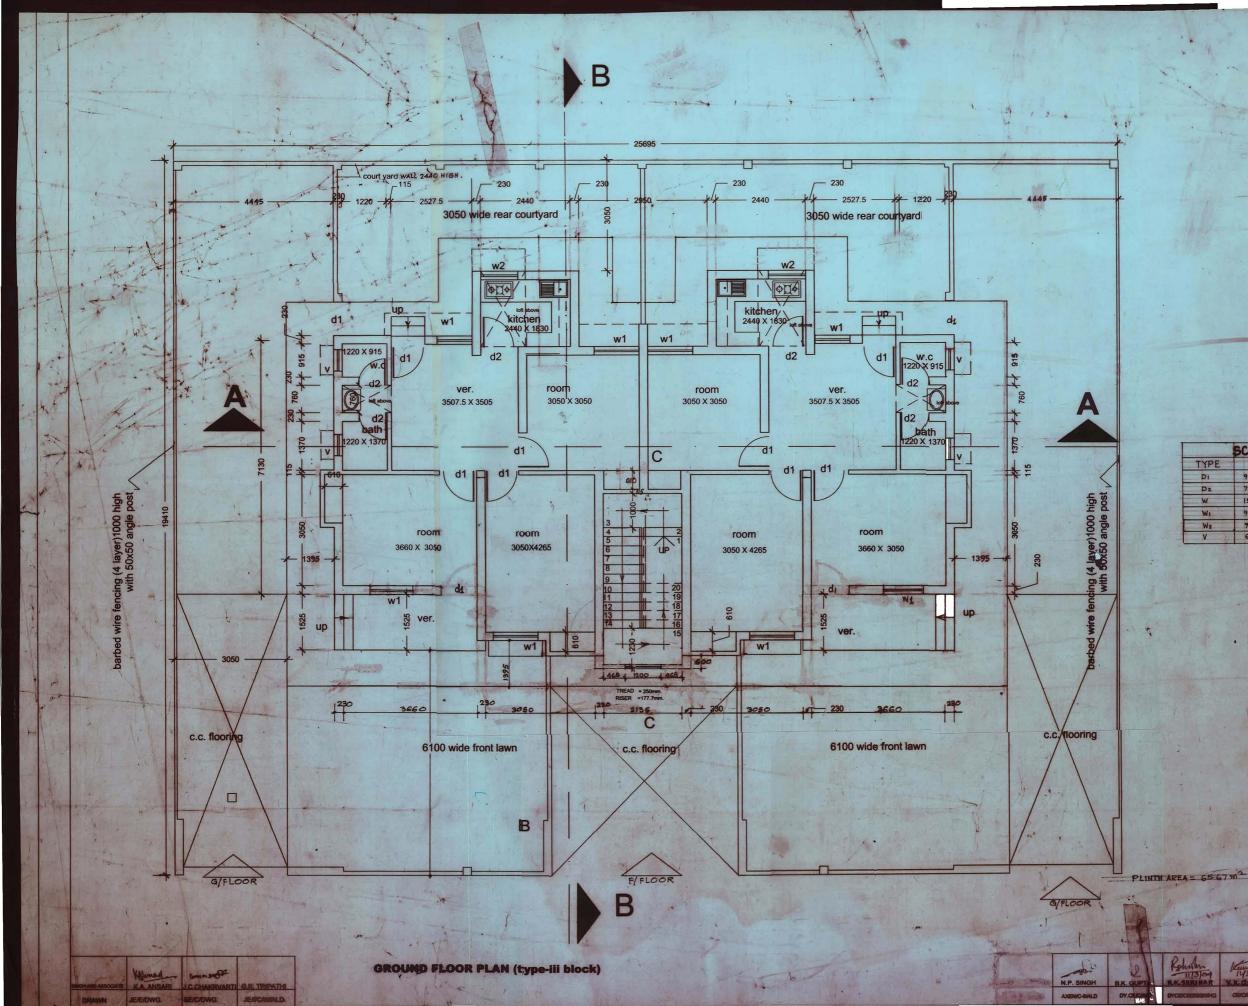

	K-51-04
	NCR HOE(P) PLAN NO. P.50-02-2004 (Sh-N:1)
* 4	NCR. DY. CE./C/ALD.PLAN NO C3-259-04-ALD (Sh-N\$ 1)
1	NOTES-
	1-ALL DIMENTION ARE SHOWN IN MILLIMETERS
	2-ALL BRICKWORK TO BE DONE IN CEMENT MORTAR 14 EXCEPT IIS 78 WALLS WHICH WILL BE CONSTRUCTED IN CEMENT MORTAR 1:4
	3-PLINTH LVL IS KEPT 460 ABOVE NATURAL GROUND LVL HOWEVER THE SAME MAY BE INCREASED/DECREASED TO SUIT SITE CONDITION
	4-40 TH. DPC WITH 2 COATS OF BITUMEN APPLIED ON IT TO BE PROVIDED TO ALL WALLS AS SPECIFIED
	5-BATH AND WC FLOOR LVL TO BE KEPT LOWER BY 1020 MM TO PREVENT FLOW OF WATER OUTSIDE
	6-40 TH C.C. FLOORING FINISHED SMOOTH TO BE PROVIDED THROUG OUT THE BUILDING WITH 100MM HIGH SKIRTING . WC AND BATH TO B PROVIDED WITH SUITABLE TILES ON WALLS AS DECIDED BY ACCOUNT
	7-INSIDE OF QRS. SHALL BE CEMENT PLASTERED 1/8 WITH WHITE WASH / COLOUR WASH FOR TYPE-1, COLOUR WASH/ DISTEMPER FOR TYPE-2 & OIL BOUND/DISTEMPER FOR TYPE-3 & 4.
	8-OUT SIDE OF THE QUARTER SHALL BE CENTER PLASTERED IS EXCEPT OUT SIDE WARDROLL, OUT STOL OF WALLS AND BALCONY INCLUDING HUNG POPIERON, WITH WHITE WASH KIDL WASH IN TYPE- TYPE-2, AND TYPE-3 AND SNOWCEM (WATER PROOF PAINT) OF APPROVE UALITY IN TYPE-4
A State of the second s	9-ALL DOORS AND UNIDOWN STILL BE PAINTED WITH SUITABLE COLOUR AS DECIDED OF ENGS. INCHARGE
	10-50 MM TH. RCC JALI SHALL BE PROVIDED INFRONT OF SACASE WALL AS SPECIFIED
	11-100 MILTH.MUD PHUSKA SHALL BE PROVIDED OVER ROOF OF THE BUILDING AS PER IRS-1987.
	12- COOLER STANDS MADE OF ANGLE IRON SEC. TO BE PROVIDED ON THE WINDOWS, WHERE EVER DESIRABLE AS PER APPROVAL OF SITE ENGINEER.

	SCHEDULE	OF DOORS & WINDOWS	
TYPE	SIZE	DESCRIPTION	1
DI	900 x 2100	SINGLE LEAF FLUSH DOOR COMMERCIAL	30 MM/TH.
D2	750 x 2100	31	1 States
W	1590 x 1370	STEEL "Z" SEC. FRAME FULLY GLAZED	WITH GRILL
WI	900 × 1370	21	
W2	700 x 1140	22	- C - C
V	600 x 450	22 WITH	TOP HINGES

