
Typical GAD of Auto Location Hut

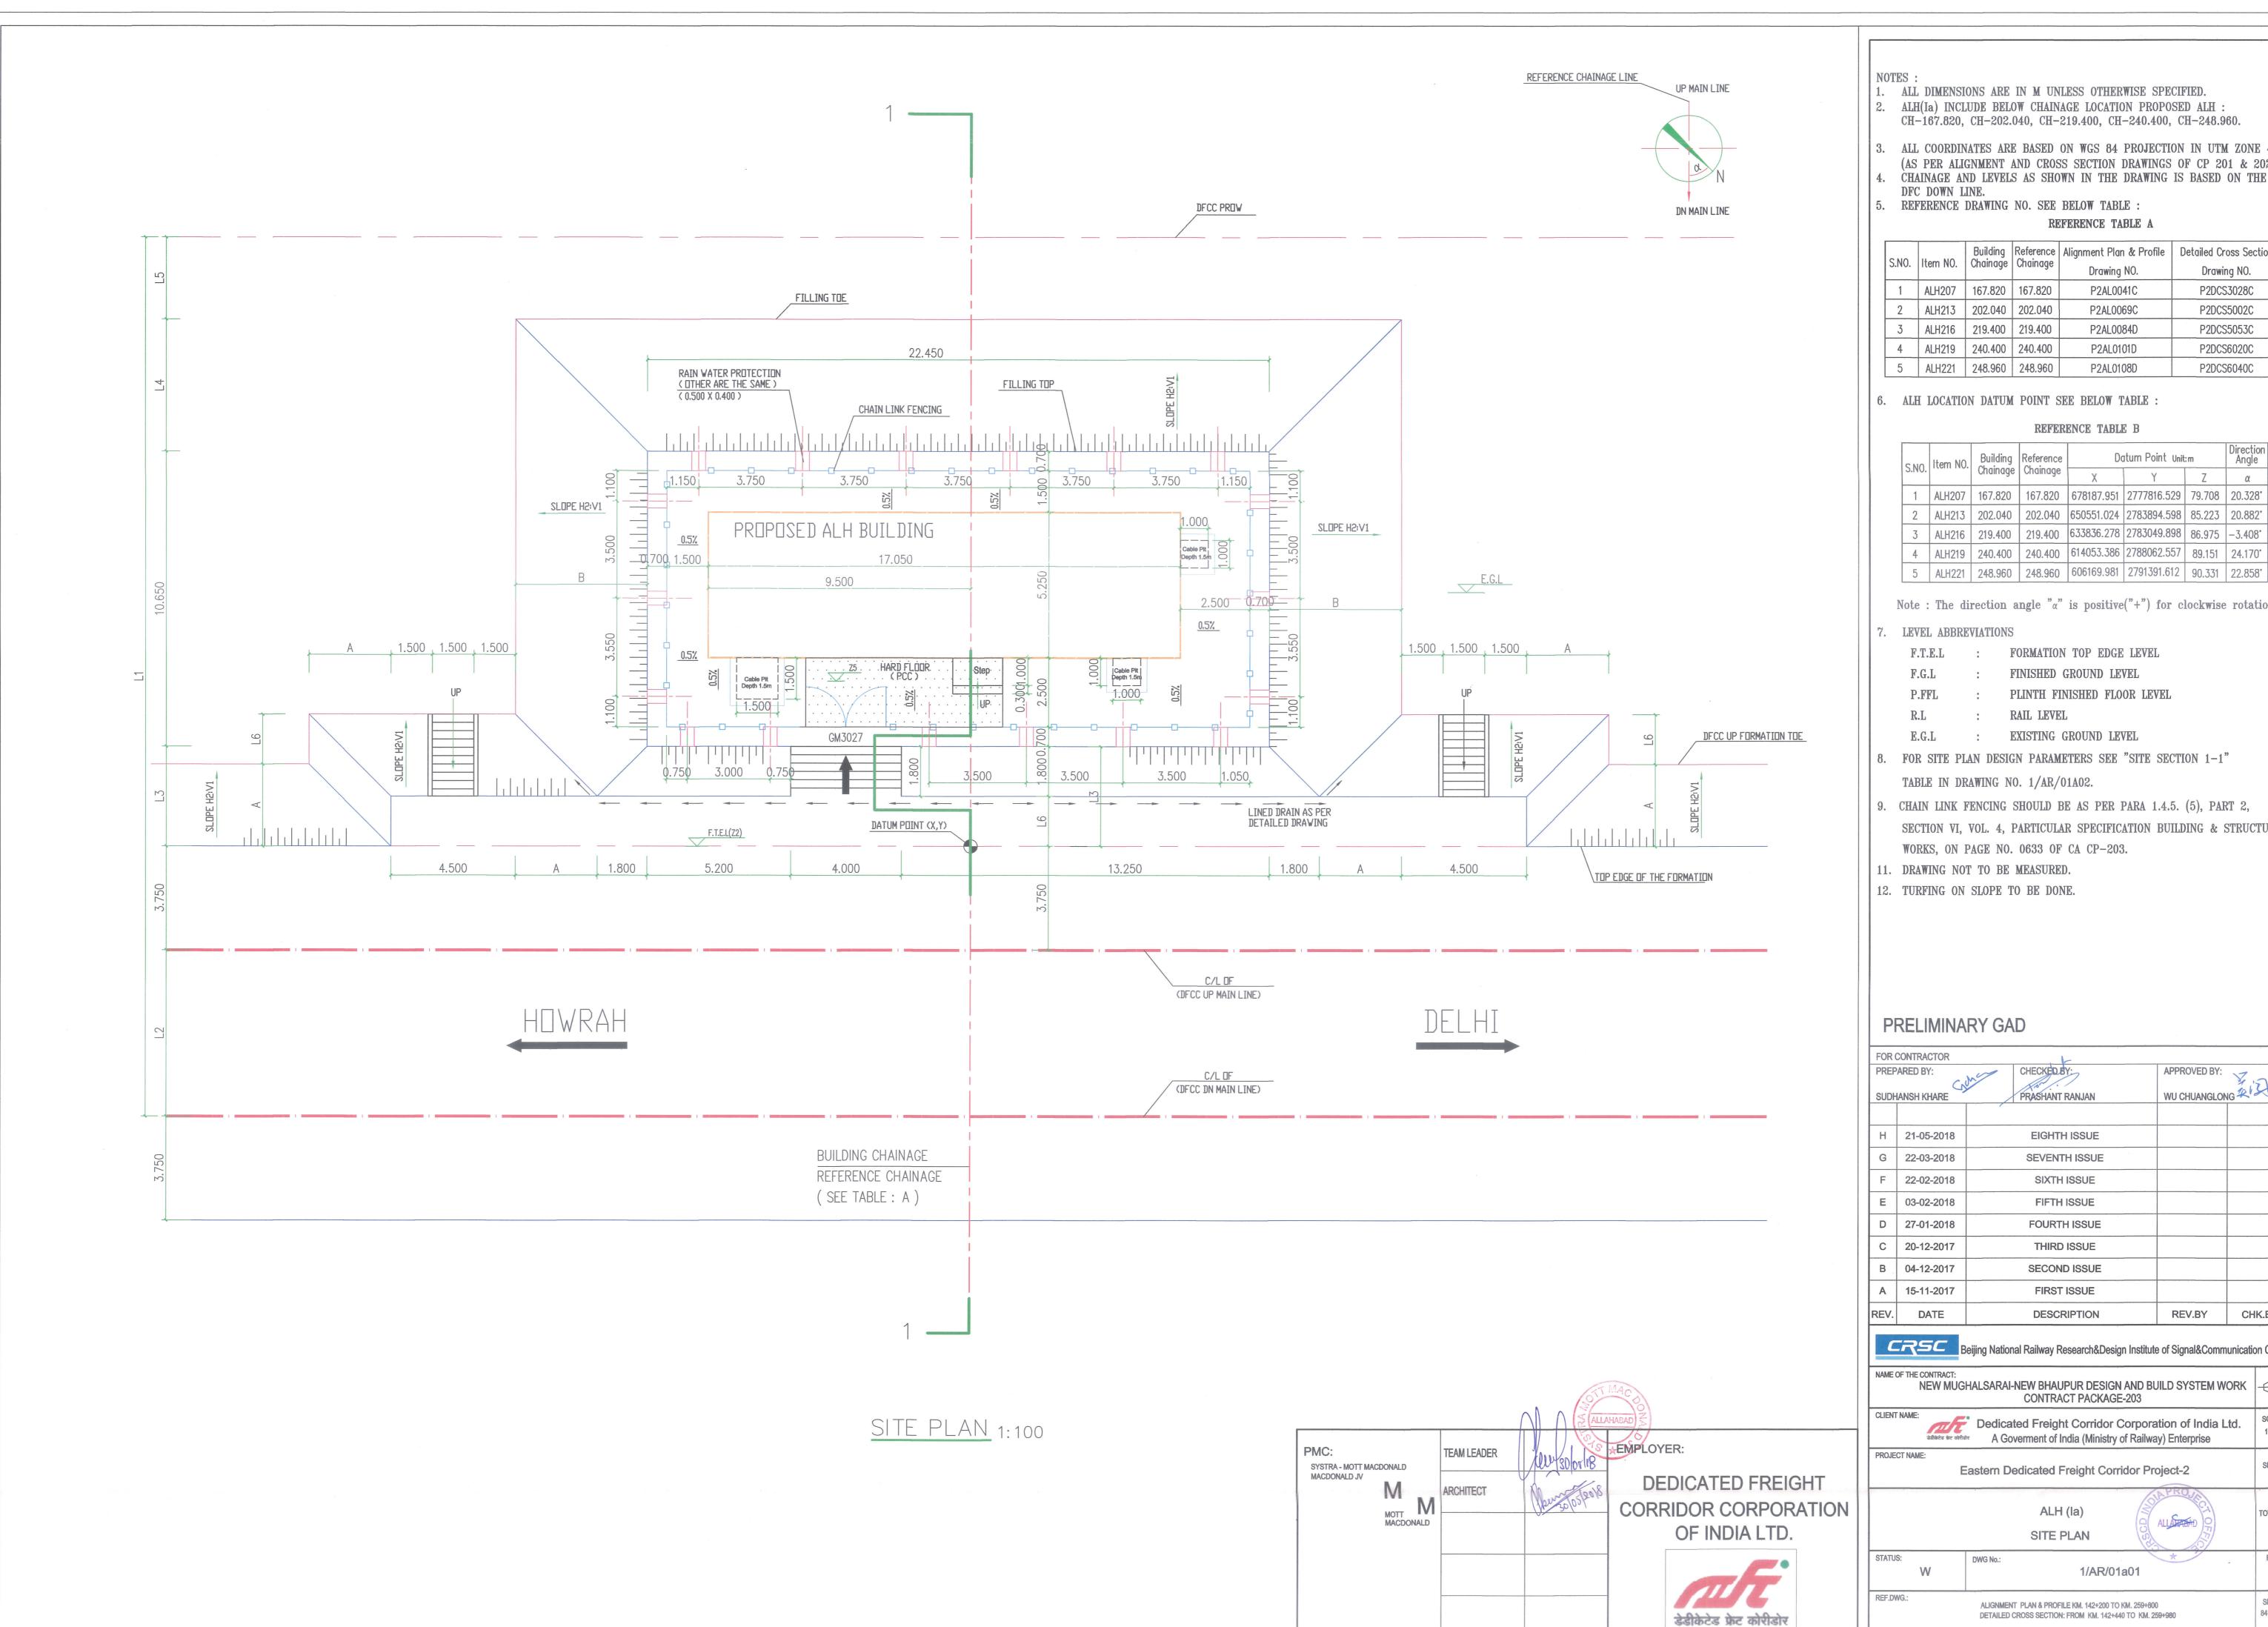

- ALL DIMENSIONS ARE IN M UNLESS OTHERWISE SPECIFIED. ALH(Ia) INCLUDE BELOW CHAINAGE LOCATION PROPOSED ALH:
- DFC DOWN LINE. REFERENCE DRAWING NO. SEE BELOW TABLE:

## REFERENCE TABLE A

CNO		Building		Alignment Plan & Profile	Detailed Cross Section
S.NO.	Item NO.	Chainage	Chainage	Drawing NO.	Drawing NO.
1	ALH207	167.820	167.820	P2AL0041C	P2DCS3028C
2	ALH213	202.040	202.040	P2AL0069C	P2DCS5002C
3	ALH216	219.400	219.400	P2AL0084D	P2DCS5053C
4	ALH219	240.400	240.400	P2AL0101D	P2DCS6020C
5	ALH221	248.960	248.960	P2AL0108D	P2DCS6040C

6. ALH LOCATION DATUM POINT SEE BELOW TABLE:

#### REFERENCE TABLE B

S.NO.	Item NO.	Building	Reference				Angle
5.110.		Chainage	Chainage	Χ	Υ	Z	α
1	ALH207	167.820	167.820	678187.951	2777816.529	79.708	20.328*
2	ALH213	202.040	202.040	650551.024	2783894.598	85.223	20.882*
3	ALH216	219.400	219.400	633836.278	2783049.898	86.975	-3.408°
4	ALH219	240.400	240.400	614053.386	2788062.557	89.151	24.170°
5	ALH221	248.960	248.960	606169.981	2791391.612	90.331	22.858*

Note: The direction angle " $\alpha$ " is positive("+") for clockwise rotation.

### LEVEL ABBREVIATIONS

FORMATION TOP EDGE LEVEL

FINISHED GROUND LEVEL

PLINTH FINISHED FLOOR LEVEL

RAIL LEVEL

EXISTING GROUND LEVEL

TABLE IN DRAWING NO. 1/AR/01A02.

- CHAIN LINK FENCING SHOULD BE AS PER PARA 1.4.5. (5), PART 2, SECTION VI, VOL. 4, PARTICULAR SPECIFICATION BUILDING & STRUCTURE WORKS, ON PAGE NO. 0633 OF CA CP-203.
- 11. DRAWING NOT TO BE MEASURED.
- 12. TURFING ON SLOPE TO BE DONE.

# PRELIMINARY GAD

DDED	ARED BY:	CHECKED BY:	APPROVED BY:	
PREP	ARED DT.	CHECKED.BY:		Y in
SUDH	IANSH KHARE	PRASHANT RANJAN	WU CHUANGLON	NG P
Н	21-05-2018	EIGHTH ISSUE		
G	22-03-2018	SEVENTH ISSUE		
F	22-02-2018	SIXTH ISSUE		
Е	03-02-2018	FIFTH ISSUE		
D	27-01-2018	FOURTH ISSUE		
С	20-12-2017	THIRD ISSUE		
В	04-12-2017	SECOND ISSUE		
Α	15-11-2017	FIRST ISSUE		
REV.	DATE	DESCRIPTION	REV.BY	CHK.BY

Beijing National Railway Research&Design Institute of Signal&Communication Co.,Ltd.

NAME OF THE CONTRACT:
NEW MUGHALSARAI-NEW BHAUPUR DESIGN AND BUILD SYSTEM WORK
CONTRACT PACKAGE-203 Dedicated Freight Corridor Corporation of India Ltd.


A Government of India (Ministry of Railway) Enterprise Eastern Dedicated Freight Corridor Project-2

ALH (la) SITE PLAN

TOT.SHEET REV. 1/AR/01a01 SH.SIZE 841 X 594 ALIGNMENT PLAN & PROFILE KM. 142+200 TO KM. 259+800 DETAILED CROSS SECTION: FROM KM. 142+440 TO KM. 259+980

MM

Typical GAD of Auto Location Hut

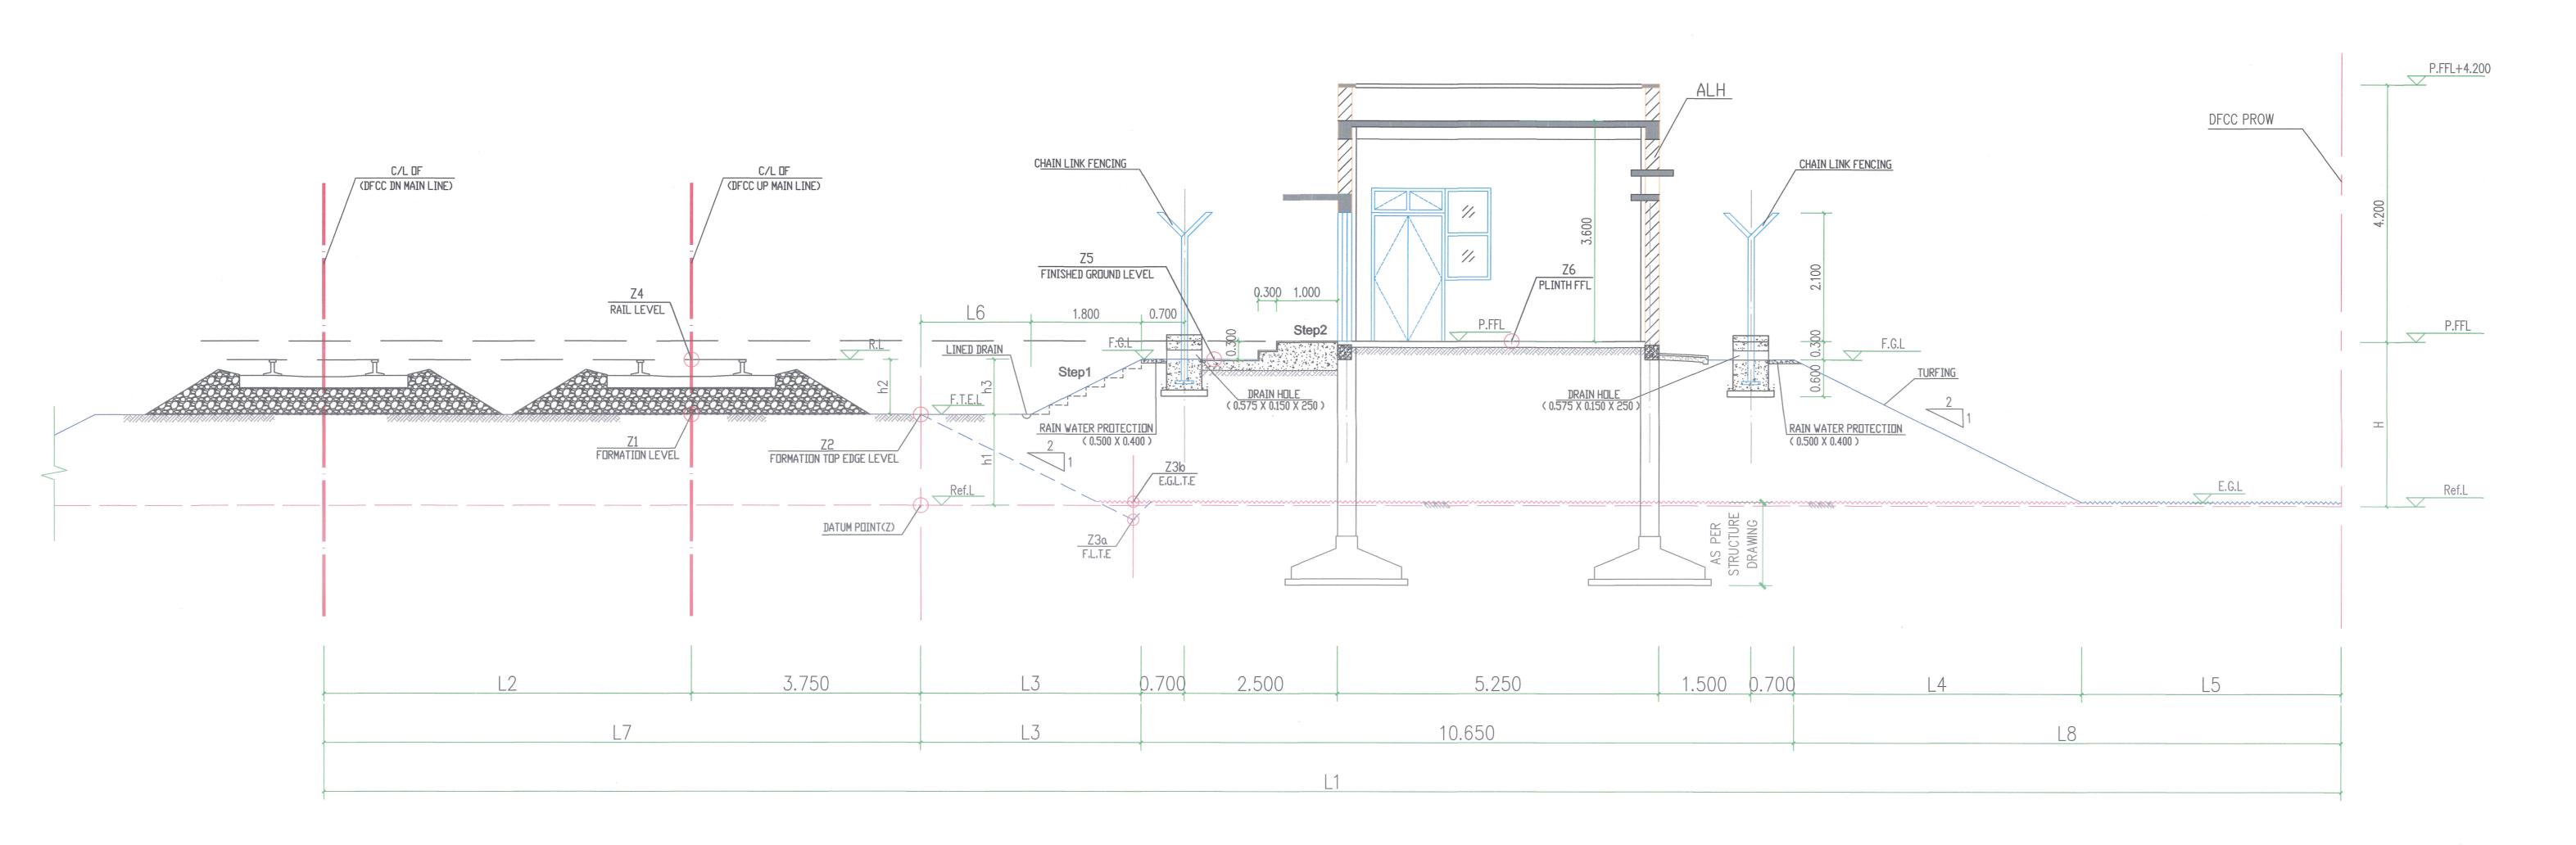

# SITE SECTION 1-1

## ALH SITE PROFILE PARAMETERS

					Ref. Level	Levels at 'Re	eference Chainage' as	s per approved cros	ss-section		Derived Levels		L	evel Difference (Heig	ht/Depth)												
.No. Item no.	Building Chainage	Reference Chainage	Co-ordinates of	ref. / Datum pt.	<b>Datum point</b> (Refer to the drawing)	Formation Level at the Center of UP Main Track Line	Formation Level at Top Edge of the Embakment	Formation Level at the Toe of Embakment	Existing Ground Level at the Toe of Embakment	Rail Level	Finished Ground Level	Plinth FFL	HT/DT. Of Formation  Top Edge Level  from Datum PT.	HT/DT. Of Rail Level from F.T.E.L.	HT/DT. Of F.G.L. from F.T.E.L.	HT/DT. Of Plinth FFL from Datum pt.					Distance						Remark
			X	Υ	Z	<b>Z1</b>	<b>Z2</b>	Z3a	Z3b	Z4 (=Z1 + 0.771)	Z5 (=Z2+h3)	Z6 (=Z5 + 0.3)	h1 (=Z2 - Z)	h2 (= <b>Z4-Z2</b> )	h3 (≥h2)	H (=Z6-Z)	A(=2 x h1) (see site plan)	B{=2 x (h1+h3)} (see site plan)	L1	L2	L3 (=L6+1.800)	L4	L5	L6	L7	L8	
1 ALH 207	167.820	167.820	678187.951	2777816.529	79.708	81.550	81.427	79.712	79.929	82.321	82.328	82.628	1.719	0.894	0.901	2.920	3.438	5.240	45.729	6.001	3.600	5.240	16.488	1.800	9.751	21.728	
2 ALH 213	202.040	202.040	650551.024	2783894.598	85.223	85.505	85.381	83.666	85.180	86.276	86.283	86.583	0.158	0.895	0.902	1.360	0.316	2.120	38.577	6.015	3.600	2.120	12.442	1.800	9.765	14.562	
3 ALH 216	219.400	219.400	633836.278	2783049.898	86.975	88.578	88.455	86.740	87.034	89.349	89.355	89.655	1.480	0.894	0.900	2.680	2.960	4.760	72.027	6.000	3.600	4.760	43.267	1.800	9.750	48.027	
ALH 219	240.400	240.400	614053.386	2788062.557	89.151	90.013	89.889	88.174	89.067	90.784	90.791	91.091	0.738	0.895	0.902	1.940	1.476	3.280	28.798	6.001	3.600	3.280	1.517	1.800	9.751	4.797	
ALH 221	248.960	248.960	606169.981	2791391.612	90.331	91.399	91.276	89.561	90.349	92.170	92.171	92.471	0.945	0.894	0.895	2.140	1.890	3.680	30.514	6.000	3.600	3.680	2.835	1.800	9.749	6.515	f



### MOTEC.

- 1. ALL DIMENSIONS ARE IN M UNLESS OTHERWISE SPECIFIED.
- 2. ALH(Ia) INCLUDE BELOW CHAINAGE LOCATION PROPOSED ALH:
- 3. ALL COORDINATES ARE BASED ON WGS 84 PROJECTION IN UTM ZONE
- 4. CHAINAGE AND LEVELS AS SHOWN IN THE DRAWING IS BASED ON THE DFC DOWN LINE.
  - REFERENCE DRAWING NO. SEE BELOW TABLE : REFERENCE TABLE A

0.110	Item NO.	Building	Reference	Alignment Plan & Profile	Detailed Cross Section
S.NO.		Chainage	Chainage	Drawing NO.	Drawing NO.
1	ALH207	167.820	167.820	P2AL0041C	P2DCS3028C
2	ALH213	202.040	202.040	P2AL0069C	P2DCS5002C
3	ALH216	219.400	219.400	P2AL0084D	P2DCS5053C
4	ALH219	240.400	240.400	P2AL0101D	P2DCS6020C
5	ALH221	248.960	248.960	P2AL0108D	P2DCS6040C

6. ALH LOCATION DATUM POINT SEE BELOW TABLE

### REFERENCE TABLE B

	S.NO.	Item NO.		Reference	Do	:m	Direction Angle	
Ľ	3.110.		Chainage	Chainage	Χ	Υ	Z	α
	1	ALH207	167.820	167.820	678187.951	2777816.529	79.708	20.328°
	2	ALH213	202.040	202.040	650551.024	2783894.598	85.223	20.882°
	3	ALH216	219.400	219.400	633836.278	2783049.898	86.975	-3.408°
	4	ALH219	240.400	240.400	614053.386	2788062.557	89.151	24.170°
	5	ALH221	248.960	248.960	606169.981	2791391.612	90.331	22.858°

Note: The direction angle " $\alpha$ " is positive("+") for clockwise rotation.

### 7. LEVEL ABBREVIATIONS

F.T.E.L : FORMATION TOP EDGE LEVEL
F.G.L : FINISHED GROUND LEVEL

P.FFL : PLINTH FINISHED FLOOR LEVEL

R.L : RAIL LEVEL

.G.L : EXISTING GROUND LEVEL

F.L.T.E : FORMATION LEVEL AT THE TOE OF EMBANKMENT

E.G.L.T.E : EXISTING GROUND LEVEL AT THE TOE OF EMBANKMENT

THIS DRAWING TO BE READ IN CONJUNCTION WITH DRAWING

## NO. 1/AR/01a01.

- 9. CHAIN LINK FENCING SHOULD BE AS PER PARA 1.4.5. (5), PART 2,
  SECTION VI, VOL. 4, PARTICULAR SPECIFICATION BUILDING & STRUCTURE
  WORKS, ON PAGE NO. 0633 OF CA CP-203.
- 10. DRAWING NOT TO BE MEASURED.
- 11. TURFING ON SLOPE TO BE DONE.

## PRELIMINARY GAD

PREP	ARED BY:	CHECKED BY:	APPROVED BY:	V
SUDH	ANSH KHARE	PRASHANT RANJAN	WU CHUANGLOI	vo2014ta
Н	21-05-2018	EIGHTH ISSUE		
G	22-03-2018	SEVENTH ISSUE		
F	22-02-2018	SIXTH ISSUE		
Е	03-02-2018	FIFTH ISSUE		
D	27-01-2018	FOURTH ISSUE		
С	20-12-2017	THIRD ISSUE		
В	04-12-2017	SECOND ISSUE		
Α	15-11-2017	FIRST ISSUE		
REV.	DATE	DESCRIPTION	REV.BY	CHK.BY

Beijing National Railway Research&Design Institute of Signal&Communication Co.,Ltd.

NAME OF THE CONTRACT:
NEW MUGHALSARAI-NEW BHAUPUR DESIGN AND BUILD SYSTEM WORK
CONTRACT PACKAGE-203

Dedicated Freight Corridor Corporation of India Ltd.
A Government of India (Ministry of Railway) Enterprise

PROJECT NAME:

Eastern Dedicated Freight Corridor Project-2

ALH (la)

SITE SECTION I-I

ATUS: DWG No.:

1/AR/01a02

REV. H

F.DWG.:


ALIGNMENT PLAN & PROFILE KM. 142+200 TO KM. 259+800
DETAILED CROSS SECTION: FROM KM. 142+440 TO KM. 259+980

MM

Sheet No. 33 Typical GAD of Auto Location Hut

600x600mm calcium silicate panels for signal and telecom

equipment room (height upto bottom of false ceiling 2.8 m)

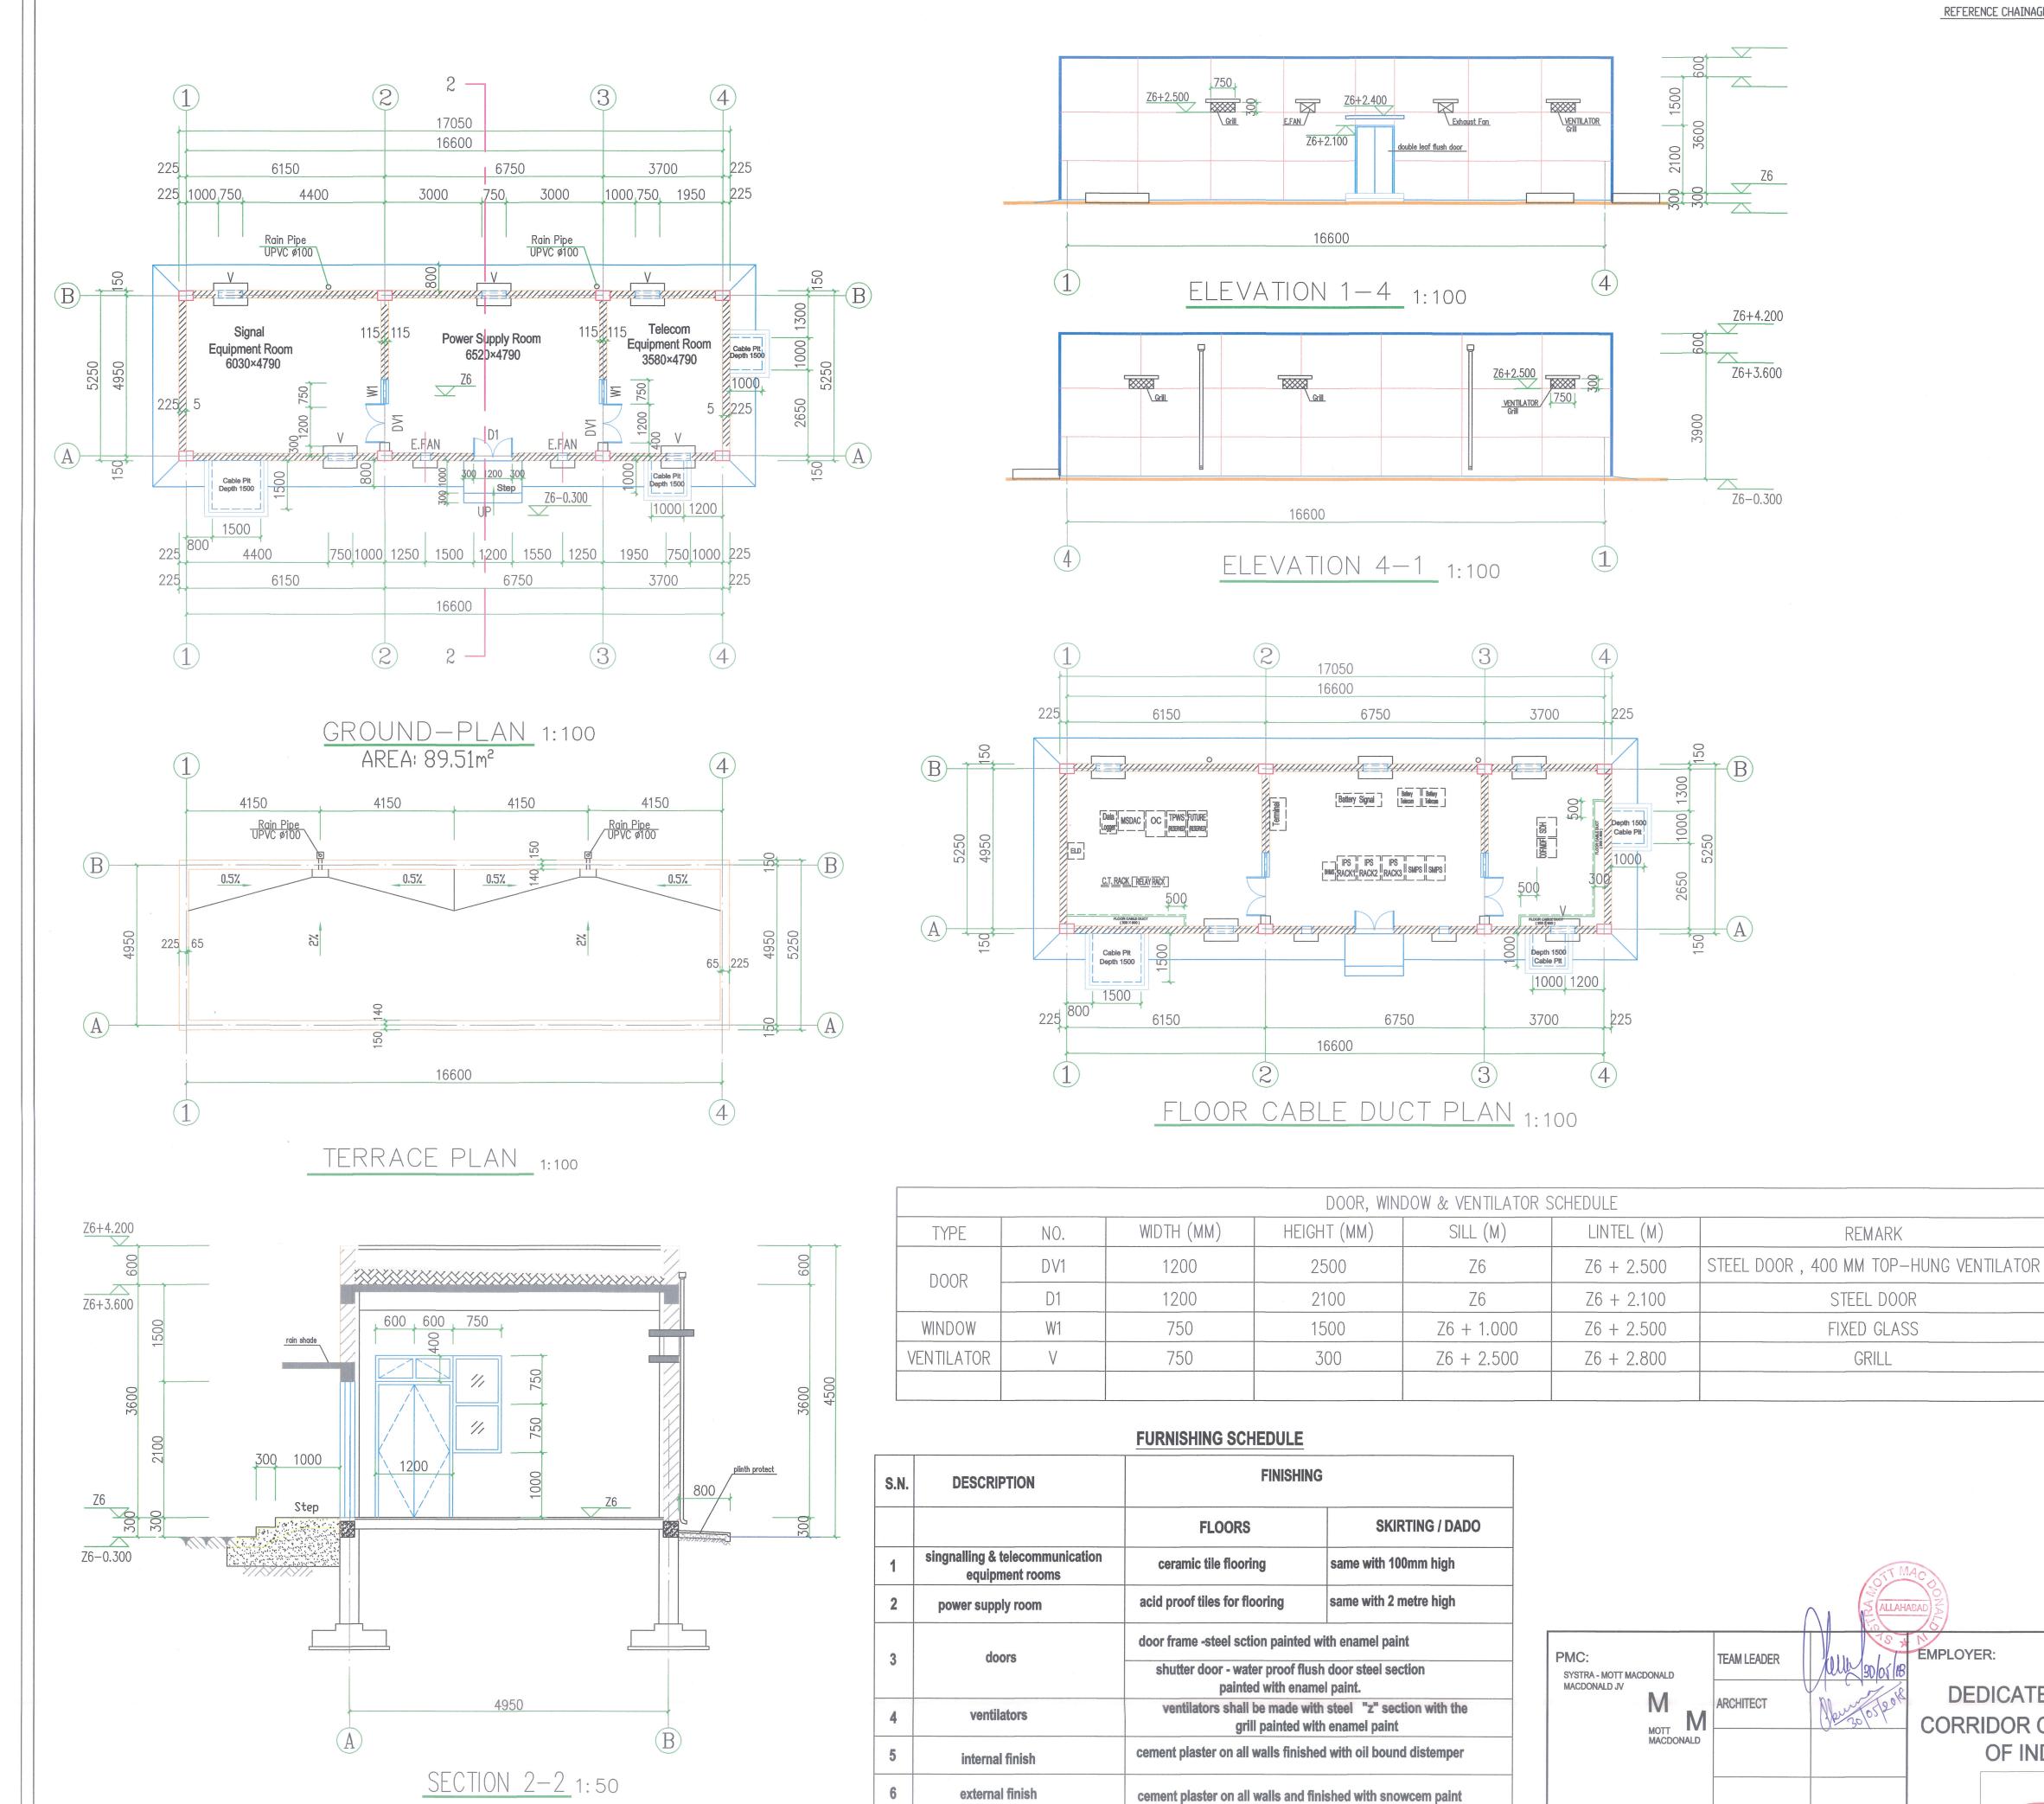

false ceilings

UP MAIN LINE

DN MAIN LINE

REFERENCE CHAINAGE LINE

DFC DOWN LINE.

- REFERENCE DRAWING NO. SEE BELOW TABLE

# REFERENCE TABLE A

NO	H NO	Building	Reference	Alignment Plan & Profile	Detailed Cross Section	
S.NO. Item NO.		Chainage	Chainage	Drawing NO.	Drawing NO.	
1	ALH207	167.820	167.820	P2AL0041C	P2DCS3028C	
2	ALH213	202.040	202.040	P2AL0069C	P2DCS5002C	
3	ALH216	219.400	219.400	P2AL0084D	P2DCS5053C	
4	ALH219	240.400	240.400	P2AL0101D	P2DCS6020C	
5	ALH221	248.960	248.960	P2AL0108D	P2DCS6040C	

ALH LOCATION DATUM POINT SEE BELOW TABLE

#### REFERENCE TABLE B

S.NO.	Item NO.		Reference	Do	atum Point Unit	:m	Direction Angle
3.110.		Chainage	Chainage	Χ	Υ	Z	α
_1	ALH207	167.820	167.820	678187.951	2777816.529	79.708	20.328
2	ALH213	202.040	202.040	650551.024	2783894.598	85.223	20.882°
3	ALH216	219.400	219.400	633836.278	2783049.898	86.975	-3.408°
4	ALH219	240.400	240.400	614053.386	2788062.557	89.151	24.170°
5	ALH221	248.960	248.960	606169.981	2791391.612	90.331	22.858°

Note: The direction angle " $\alpha$ " is positive("+") for clockwise rotation.

- 7. FOR THE ALH LOCATION SEE DRAWING NO. 1/AR/01a02.
- 8. WATERPROOFING & THERMAL INSULATION ON ROOF TO BE DONE.

## PRELIMINARY GAD

	ARED BY:	CHECKED BY: PRÄSHANT RANJAN	APPROVED BY: WU CHUANGLONG				
		T T T T T T T T T T T T T T T T T T T	We driewweet				
G	21-05-2018	SEVENTH ISSUE					
F	22-03-2018	SIXTH ISSUE					
Е	22-02-2018	FIFTH ISSUE					
D	03-02-2018	FOURTH ISSUE					
С	27-01-2018	THIRD ISSUE					
В	20-12-2017	SECOND ISSUE					
Α	04-12-2017	FIRST ISSUE					
REV.	DATE	DESCRIPTION	REV.BY	CHK.BY			

Beijing National Railway Research&Design Institute of Signal&Communication	n Co.,Ltd.
NAME OF THE CONTRACT: NEW MUGHALSARAI-NEW BHAUPUR DESIGN AND BUILD SYSTEM WORK CONTRACT PACKAGE-203	-4-
CLIENT NAME:  Dedicated Freight Corridor Corporation of India Ltd.  A Government of India (Ministry of Railway) Enterprise	SCALE 1:100
PROJECT NAME:  Eastern Dedicated Freight Corridor Project-2	SHEET 01

ALH(la) GROUND-PLAN, ELEVATION 1-4, ELEVATION 4-1

SECTION 1-1, TERRACE PLAN STATUS: REV. W 1/AR/01a03 G REF.DWG.: SH.SIZE ALIGNMENT PLAN & PROFILE KM. 142+200 TO KM. 259+800 841 X 594 DETAILED CROSS SECTION: FROM KM. 142+440 TO KM. 259+980 MM

TOT.SHEET

